

80 Wheeler Avenue / Pleasantville, New York

(914) 769-1926 Fax: (914) 769-5519

Building Department

PLEASANTVILLE PLANNING COMMISSION MEETING

To: Planning Commission Members:

There will be a meeting of the Pleasantville Planning Commission on Wednesday, April 9, 2025, at 8:00 PM, at Village Hall, 2nd Floor 80 Wheeler Avenue, Pleasantville, New York.

AGENDA

1. **Meeting Access**

Topic: Planning / ARB

Time: Apr 9, 2025 08:00 PM Eastern Time (US and Canada)

Join Zoom Meeting

https://us06web.zoom.us/j/82536072058?pwd=kbqWAQjuP9S6cV31Zg7LkSaQ4Lemwj.1

Meeting ID: 825 3607 2058

Passcode: 974183 One tap mobile

+16465588656,,82536072058# US (New York)

2. **APPLICATIONS SPECIFIC TO PLANNING COMMISSION**

3. 134 Marble Avenue

Prospero - 134 Marble Avenue - Proposal to amend prior site plan resolution and implement warehouse with retail use via Special Permit within existing first floor from prior non-conforming manufacturing, assembling and warehouse use - Public hearing & review of resolution draft

4. APPLICATIONS INVOLVING PLANNING & ARB

5. **325 Manville Road**

325 Manville Road - Manville and Grove LLC - Proposed conversion of existing professional office building into a new multiple dwelling consisting of a maximum six (6) residential apartment units - App back from ZBA - cont review & set public hearing

6. **Minutes of Meeting**

Meeting of March 12, 2025

Very truly yours

Robert Hughes Building Inspector



Meeting Access

Topic: Planning / ARB

Time: Apr 9, 2025 08:00 PM Eastern Time (US and Canada)

Join Zoom Meeting

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APPLICATIONS SPECIFIC TO PLANNING COMMISSION



134 Marble Avenue

<u>Prospero - 134 Marble Avenue</u> - Proposal to amend prior site plan resolution and implement warehouse with retail use via Special Permit within existing first floor from prior non-conforming manufacturing, assembling and warehouse use - *Public hearing & review of resolution draft*

ATTACHMENTS:

Description	Type	Upload Date
Resolution draft	Backup Material	4/9/2025
Prior architectural plans dated 1.21.25	Backup Material	4/4/2025
Public Notice	Backup Material	4/4/2025

RESOLUTION

PROSPERO – 134 MARBLE AVENUE

APPLICATION FOR AMENDED SITE PLAN AND SPECIAL PERMIT APPROVAL

After due discussion and deliberation, on motio	n by, seconded by
and carried, the following resolution was adopted:	

WHEREAS, application has been made to the Planning Commission of the Village of Pleasantville for approval of an amended site plan as depicted on a plan labeled, "S-1" entitled "Change of Use - First Floor, Interior Alterations," last revised 1/21/25, prepared by JMF Architects, said properties being located at 134 Marble Avenue, in the Medium Density Residence/Office "RO-3" Zoning District and are designated on the tax map of the Village of Pleasantville as Section 106.10, Block 2, Lots 41 & 42; and

WHEREAS, the project involves the conversion of the existing business office and warehouse use to a retail and warehouse use; and

WHEREAS, in connection with the current applications the Applicant has submitted the following materials, among others, for the Planning Commission's review:

- Application for Site Plan Approval
- Short Environmental Assessment Form;
- A set of plans generally entitled, "Change of Use For First Floor" last revised January 21, 2025, prepared by JMF Architects:
 - o Sheet T-1, "Title Sheet"
 - o Sheet S-1, "Site Plan"
 - o Sheet D-1, "Existing Conditions First Floor"
 - o Sheet A-1, "Basement/Foundation Plan"
 - o Sheet A-2, "First Floor Construction & Life Safety Plan"
 - Sheet A-3, "Elevations and Detail"
 - o Sheet A-4, "Restroom Plans & Elevations and Detail"
 - o Sheet A-5, "General Notes;" and

WHEREAS, on March 6, 2025, the Zoning Board of Appeals granted a variance from Section 185-17.1.C(1) of the Village Municipal Zoning Code to permit 20% of the gross floor area to be used for retail space where a maximum of 15% is permitted; and

WHEREAS, a duly advertised public hearing on the application for Special Use Permit and Site Plan Approval was held by the Planning Commission on April 9, 2025 at the Village Hall, 80 Wheeler Avenue, Pleasantville, New York; and

WHEREAS, on ______, on motion by ______, seconded by _____ and carried, the public hearing on said application was closed; and

WHEREAS, on April 9, 2025, the Planning Commission determined that the Proposed Action is a Type II Action because it proposes a change in use of a nonresidential structure involving less than 4,000 square feet of gross floor area and, therefore, requires no further processing under the New York State Environmental Quality Review Act (SEQRA) regulations; and

WHEREAS, in granting a special permit for a retail use incidental to a warehouse in accordance with the provisions of § 185-56, the Planning Commission has determined the following:

- 1. All proposed structures, equipment and material will be readily accessible for fire and police protection.
- 2. The proposed use will be of such location, size and character that, in general, it will be in harmony with the appropriate and orderly development of the district in which it is proposed to be situated and will not be detrimental to the orderly development of adjacent properties, in accordance with the zoning classification of such properties.
- 3. The location and size of such use, the nature and intensity of operations involved in or conducted in connection therewith, its site layout and its relation to access streets shall be such that both pedestrian and vehicular traffic to and from the use and the assembly of persons in connection therewith will not be hazardous or inconvenient to or incongruous with the district or conflict with the normal traffic of the neighborhood.
- 4. The location and height of buildings, the location, nature and height of walls and fences and the nature and extent of screening and landscaping on the site shall be such that the use will not hinder or discourage the appropriate orderly development and use of adjacent land and buildings or impair the value thereof.
- 5. The site plan for such use has been designed to ensure the accomplishment of the objectives set forth in § 185-50E of the Code of the Village of Pleasantville; and

WHEREAS, the Planning Commission is familiar with and has inspected the premises; and

WHEREAS, the Planning Commission has carefully considered all of the comments raised by the public and other interested agencies, organizations and officials, including those presented at the meetings of the Commission; and

WHEREAS, under the Village Law the approval of said application for approval by this Planning Commission does not affect the power of the Village to change zoning regulations, nor act as an assurance of the granting of any building permits; and

NOW, THEREFORE, BE IT RESOLVED, that the Planning Commission hereby grants Site Plan and Special Permit Approval to the Project, as shown on the Site Plan Drawings and other application materials enumerated above, subject to compliance with the following conditions and any other requirements which must be met by law:

- 1. All references to "the Applicant" shall include the Applicant's successors and assigns.
- 2. Compliance with all applicable local laws and ordinances of the Village of Pleasantville and any conditions attached to the permits issued thereunder.
- 3. Prior to the issuance of a building permit, payment of all fees for the cost of engineering, planning, environmental, or other technical services required in connection with the review of this application shall be required.
- 4. No site disturbance shall be permitted on the subject site until the Village of Pleasantville Building Inspector has issued a building permit and has inspected the installation of all required soil erosion and sedimentation control measures.

BE IT FURTHER RESOLVED, that pursuant to Section 185-50.F.(11) of the Code of the Village of Pleasantville, this site plan amendment approval shall expire one hundred and twenty (120) days from the date of signing of the final site plan by the Planning Commission Chairman, unless a building permit has been issued or an extension has been granted by the Planning Commission as permitted by the Village Zoning Law; and

BE IT FURTHER RESOLVED that this special permit shall be renewed every five (5) years based upon the date on which the approved resolution was filed with the Village Clerk. At any time prior to the required renewal date, the Applicant may submit an application to the Building Inspector for the purpose of renewing the special permit in accordance with the provisions of § 185-56G of the Zoning Law of the Village of Pleasantville; and

BE IT FURTHER RESOLVED, that, except as otherwise expressly amended herein, all other terms, provisions and conditions of the Planning Commission Resolution of Approval entitled "Prospero – 134 Marble Avenue Applications for Preliminary and Final Subdivision and Amended Site Plan Approval," adopted by the Planning Commission on

September 27, 2023, is incorporated herein by reference and shall remain in full force and effect; and

BE IT FURTHER RESOLVED, that if said conditions be not fully complied with within the above time limits, that said site plan amendment shall be disapproved.

VOTE: Ayes –

Noes -

Abstentions - Absent –

DATE: April 9, 2025


CERTIFICATION:

Russell Klein, Chairman

Village of Pleasantville Planning Commission

CHANGE OF USE FOR FIRST FLOOR 134 MARBLE AVENUE PLEASANTVILE, NY

SECTION 106.10, BLOCK 2, LOTS 41 & 42

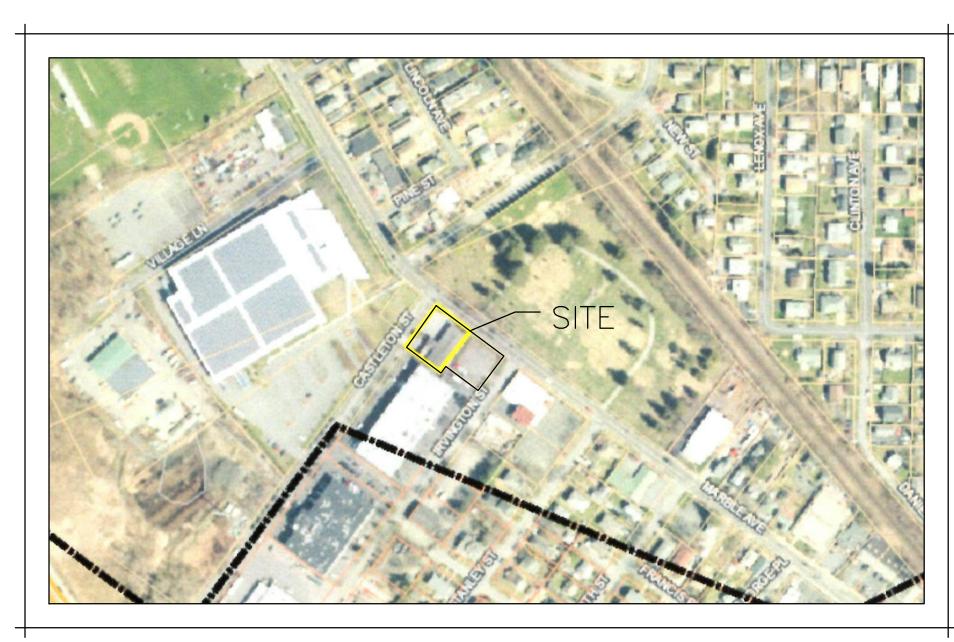

SITE LOCATION

		INDEX OF DRAWINGS		
134 M	IARBLE AVE (SE	CTION 106.10, BLOCK 2, LOT 41 & 42)		
No.	DRAWING	DRAWING TITLE	REV.	DATE
GENER	RAL			·
1	T-1	TITLE SHEET	6	1/21/25
CIVIL	,			'
2	S-2	SITE PLAN	7	1/21/25
ARCHI	TECTURAL			
3	D-1	EXISTING CONDITIONS — FIRST FLOOR	2	1/10/24
ARCHI	TECTURAL		•	
4	A-1	FOUNDATION PLAN	2~	1/10/24
5	A-2	FIRST FLOOR CONSTRUCTION & LIFE SAFTEY PLAN	4	1/21/25
6	A-3	ELEVATIONS AND DETAILS	4	5/29/24
7	A-4	RESTROOM PLANS & ELEVATIONS AND DETAILS	4	1/21/25
8	A-5	GENERAL NOTES	200	1/10/24~



MARBLE AVENUE




IRVINGTON STREET



CASTLETON STREET

PHASE I APPROVED BY THE VILLAGE OF PLEASANTIVILLE PLANNING COMMISSION ON SEPTEMBER 27, 2023

\bigcirc	1/21/25	CHANGE OF USE				
5	5/29/24	FIELD CHANGES BY OWNER				
4	2/16/24	PER PLANNING COMMENTS				
3	2/4/24	PER BLDG DEPT COMMENTS				
2	1/10/24	ISSUED TO PLANNING				
1	12/10/23	ISSUED FOR REVIEW				
lo.	Date	Comments				
REVISIONS						

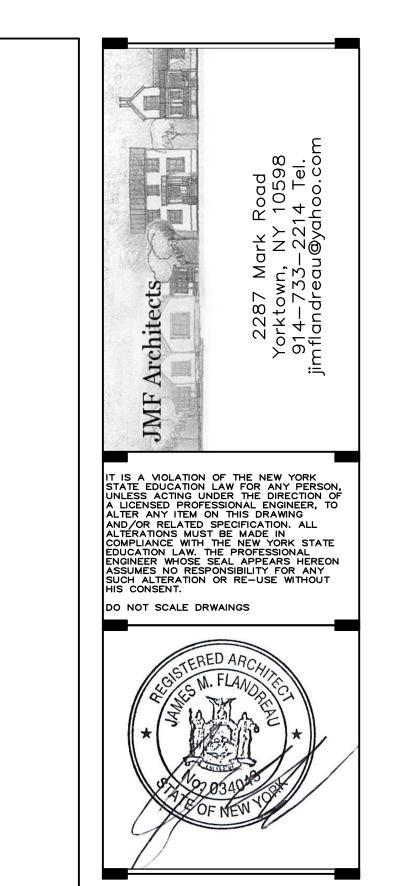

CHANGE OF USE - FIRST FLOOR
INTERIOR ALTERATIONS
Drawing Title
TITLE SHEET

PROSPERO
134 MARBLE AVE
PLEASANTVILLE, NY


Original Date:


11/6/23

Project No:

23-50

T-1

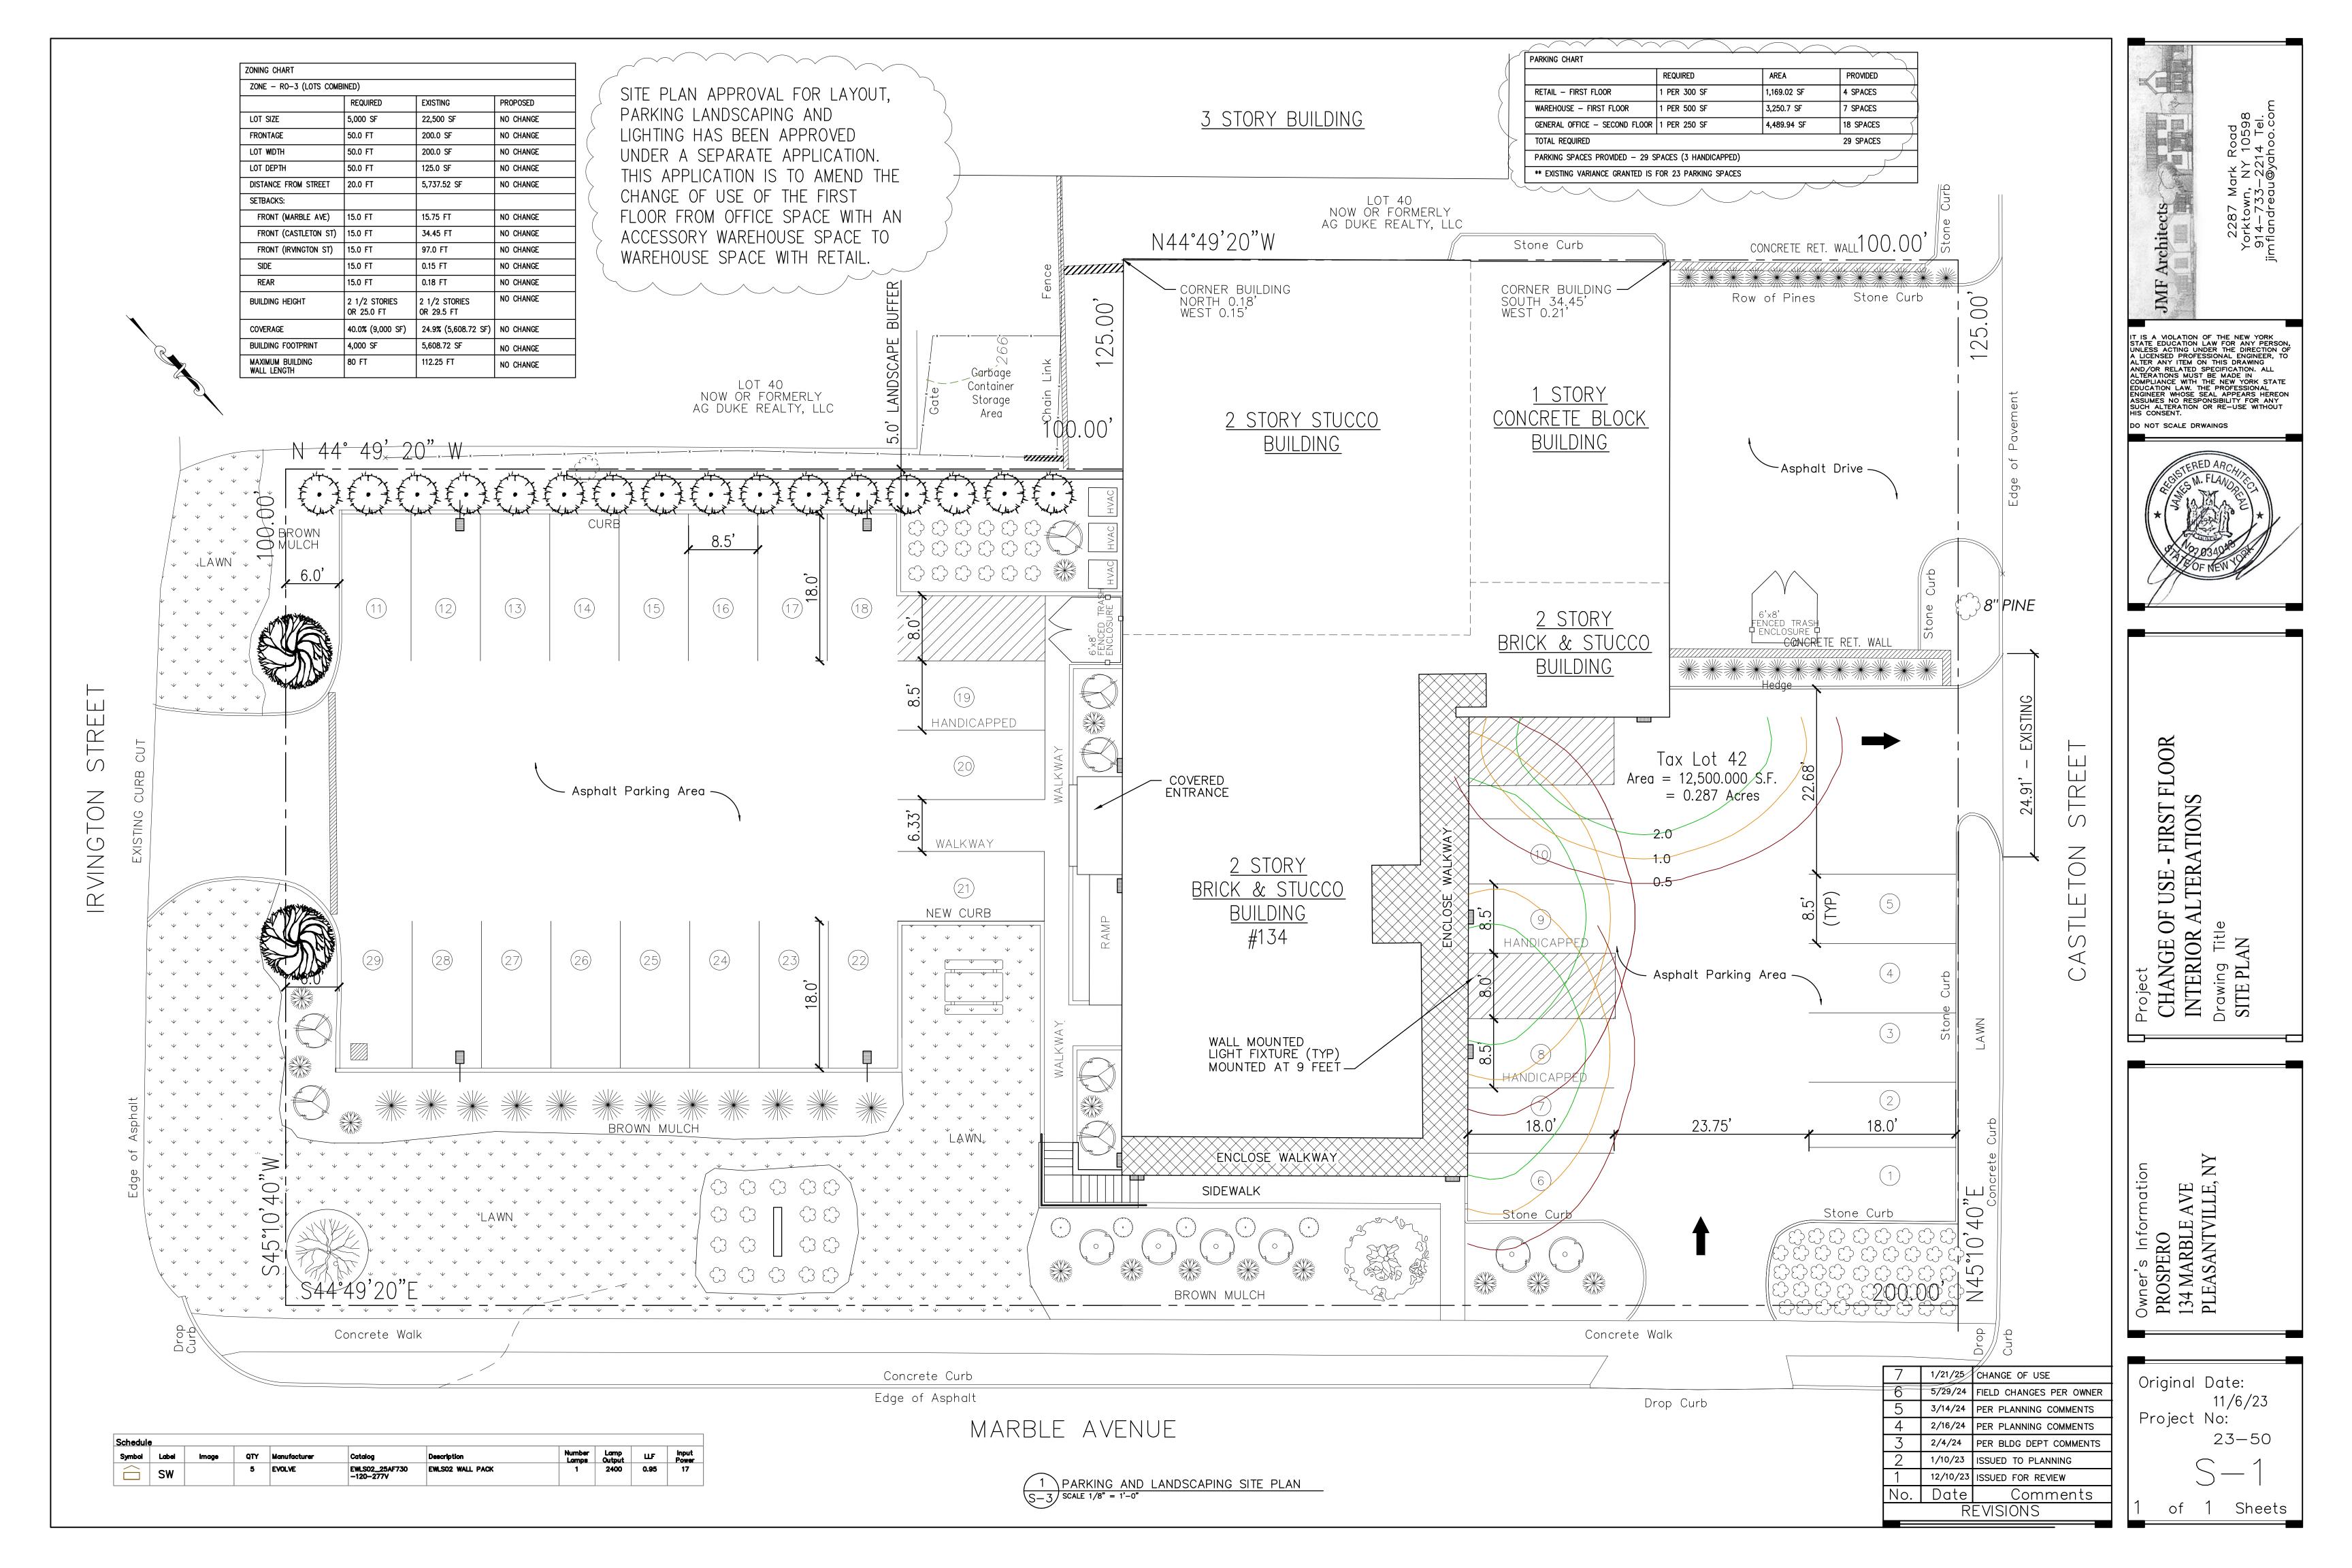

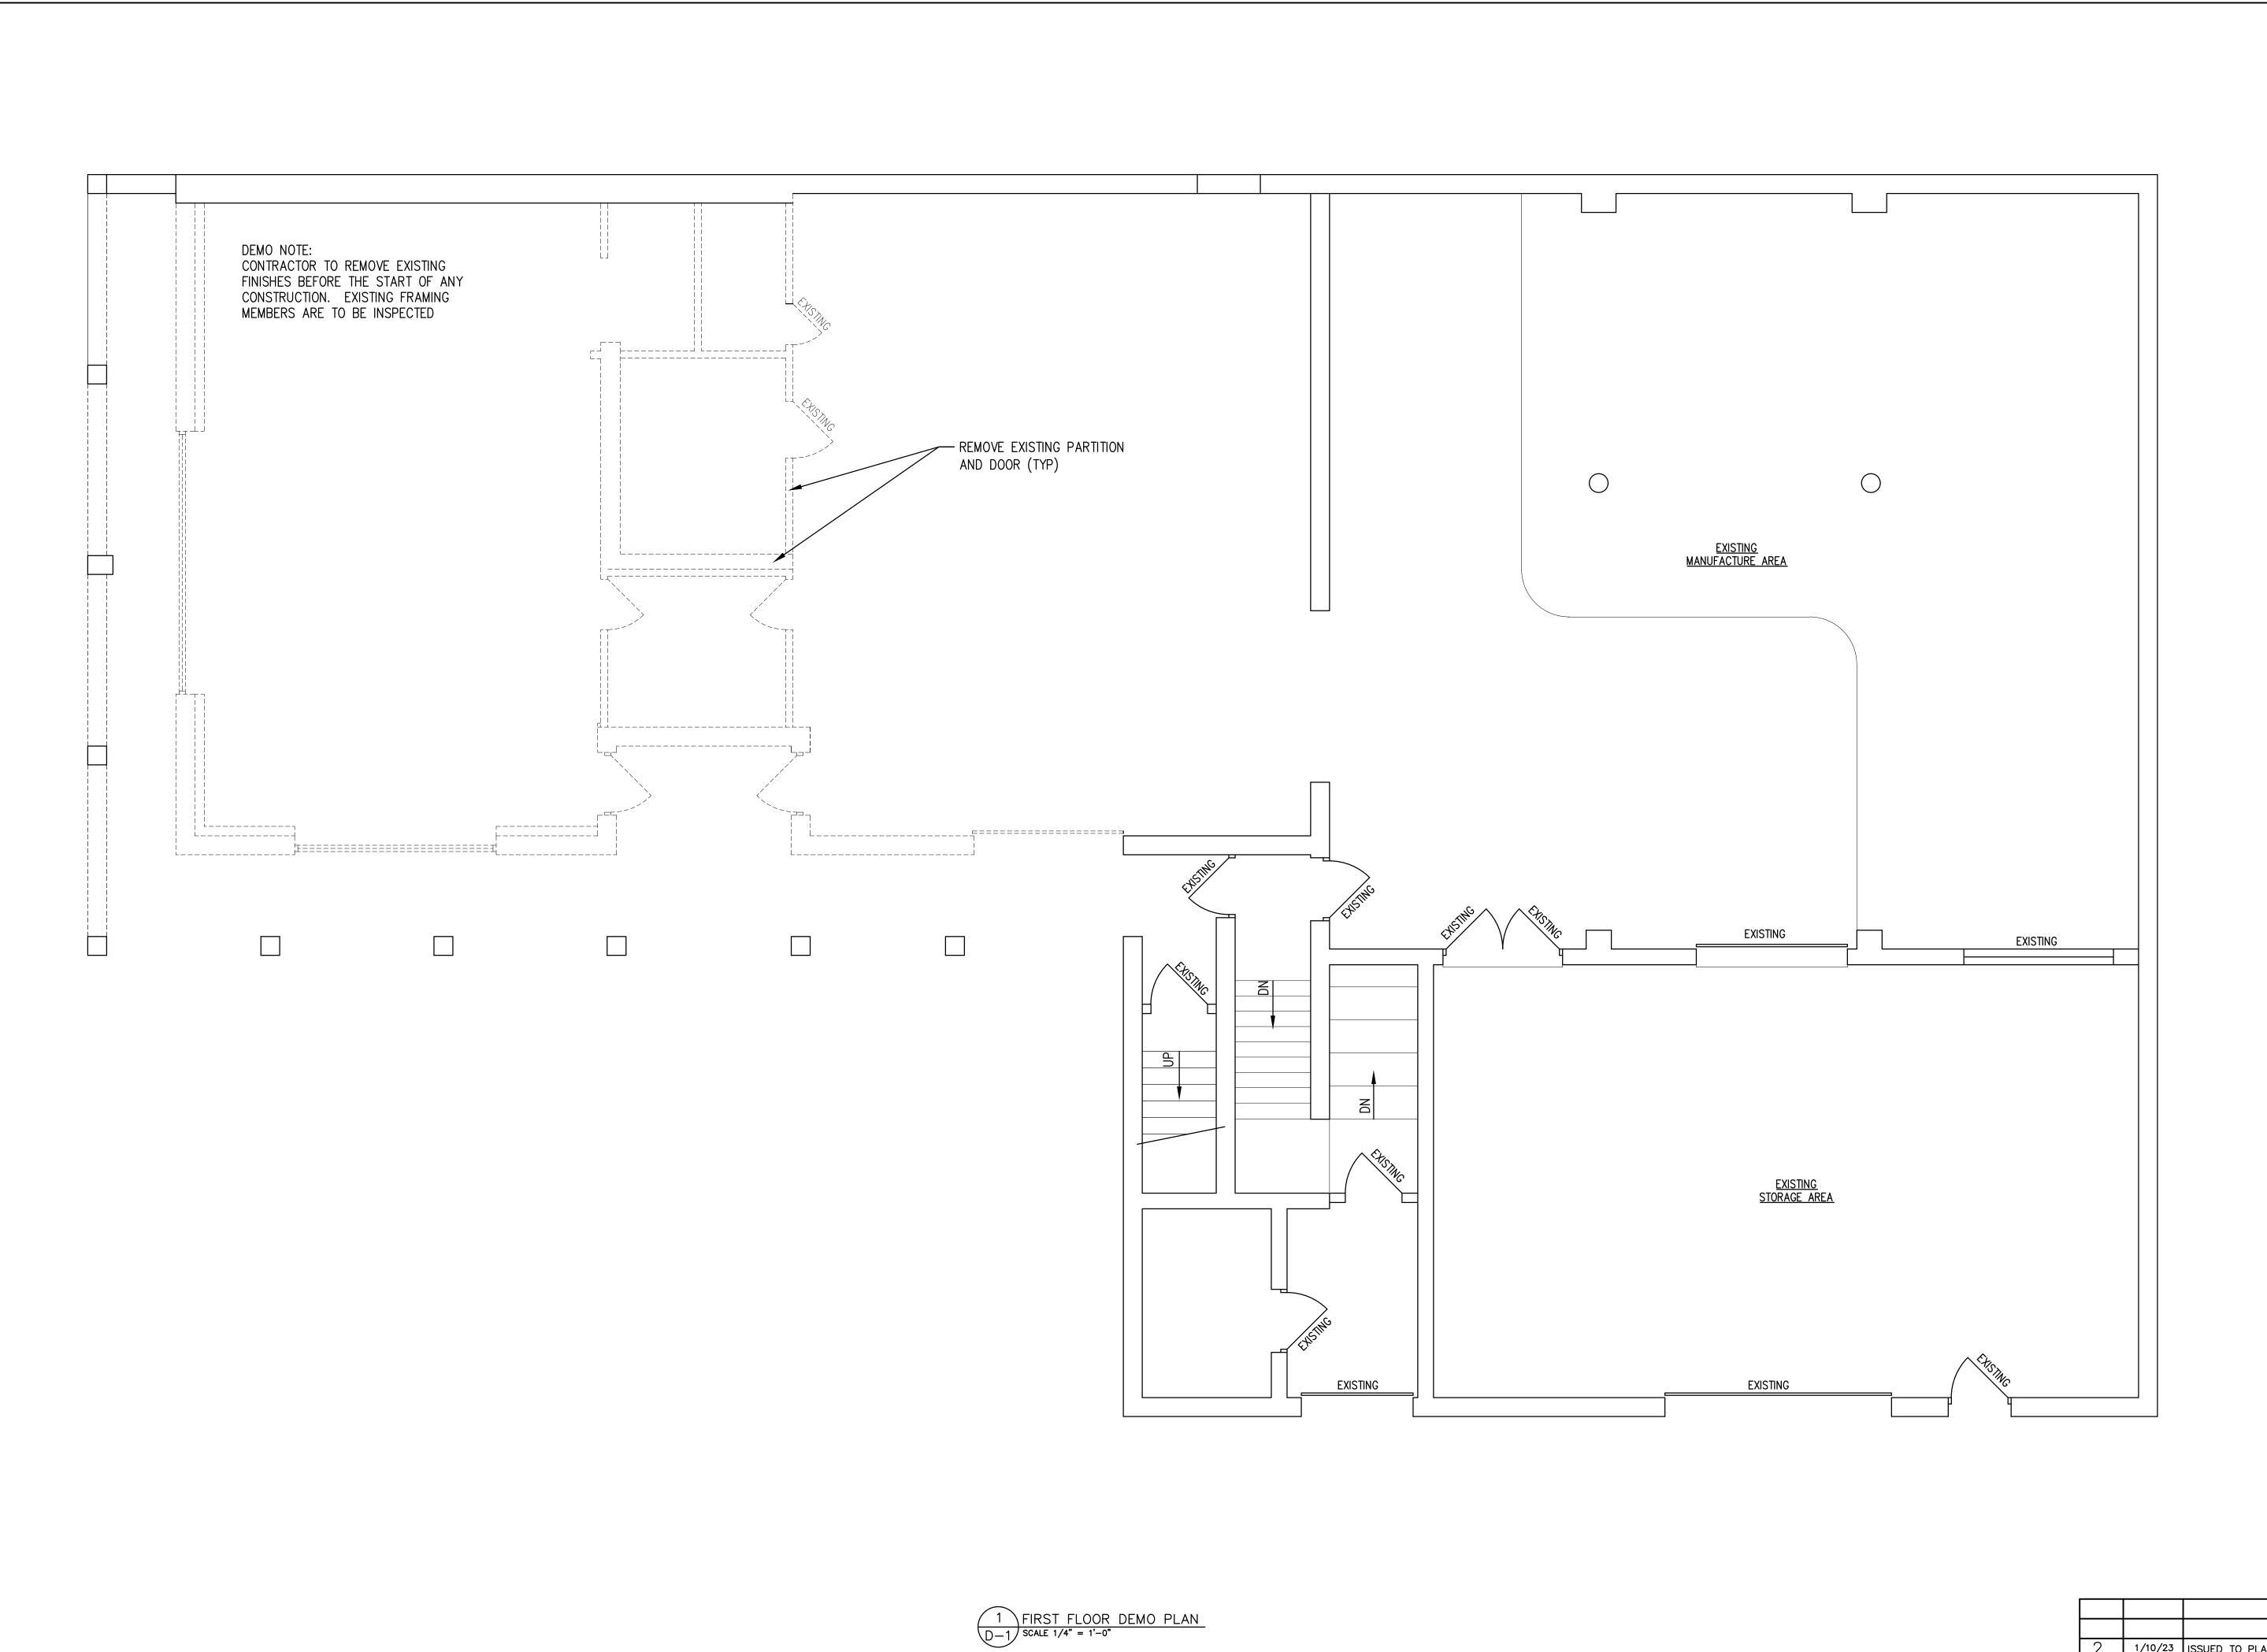

 2 1/10/23 ISSUED TO PLANNING
 1 12/10/23 ISSUED FOR REVIEW te Comments REVISIONS Owner's Information PROSPERO 134 MARBLE AVE PLEASANTVILLE, NY Original Date:

11/6/23 Project No:


Project
CHANGE OF USE - FIRST FI
INTERIOR ALTERATIONS
Drawing Title
EXISTING CONDITIONS - FIRST

IT IS A VIOLATION OF THE NEW YORK STATE EDUCATION LAW FOR ANY PERSON, UNLESS ACTING UNDER THE DIRECTION OF A LICENSED PROFESSIONAL ENGINEER, TO ALTER ANY ITEM ON THIS DRAWING AND/OR RELATED SPECIFICATION. ALL ALTERATIONS MUST BE MADE IN COMPLIANCE WITH THE NEW YORK STATE EDUCATION LAW. THE PROFESSIONAL ENGINEER WHOSE SEAL APPEARS HEREON ASSUMES NO RESPONSIBILITY FOR ANY SUCH ALTERATION OR RE-USE WITHOUT HIS CONSENT.

DO NOT SCALE DRWAINGS

23-50

Sheets

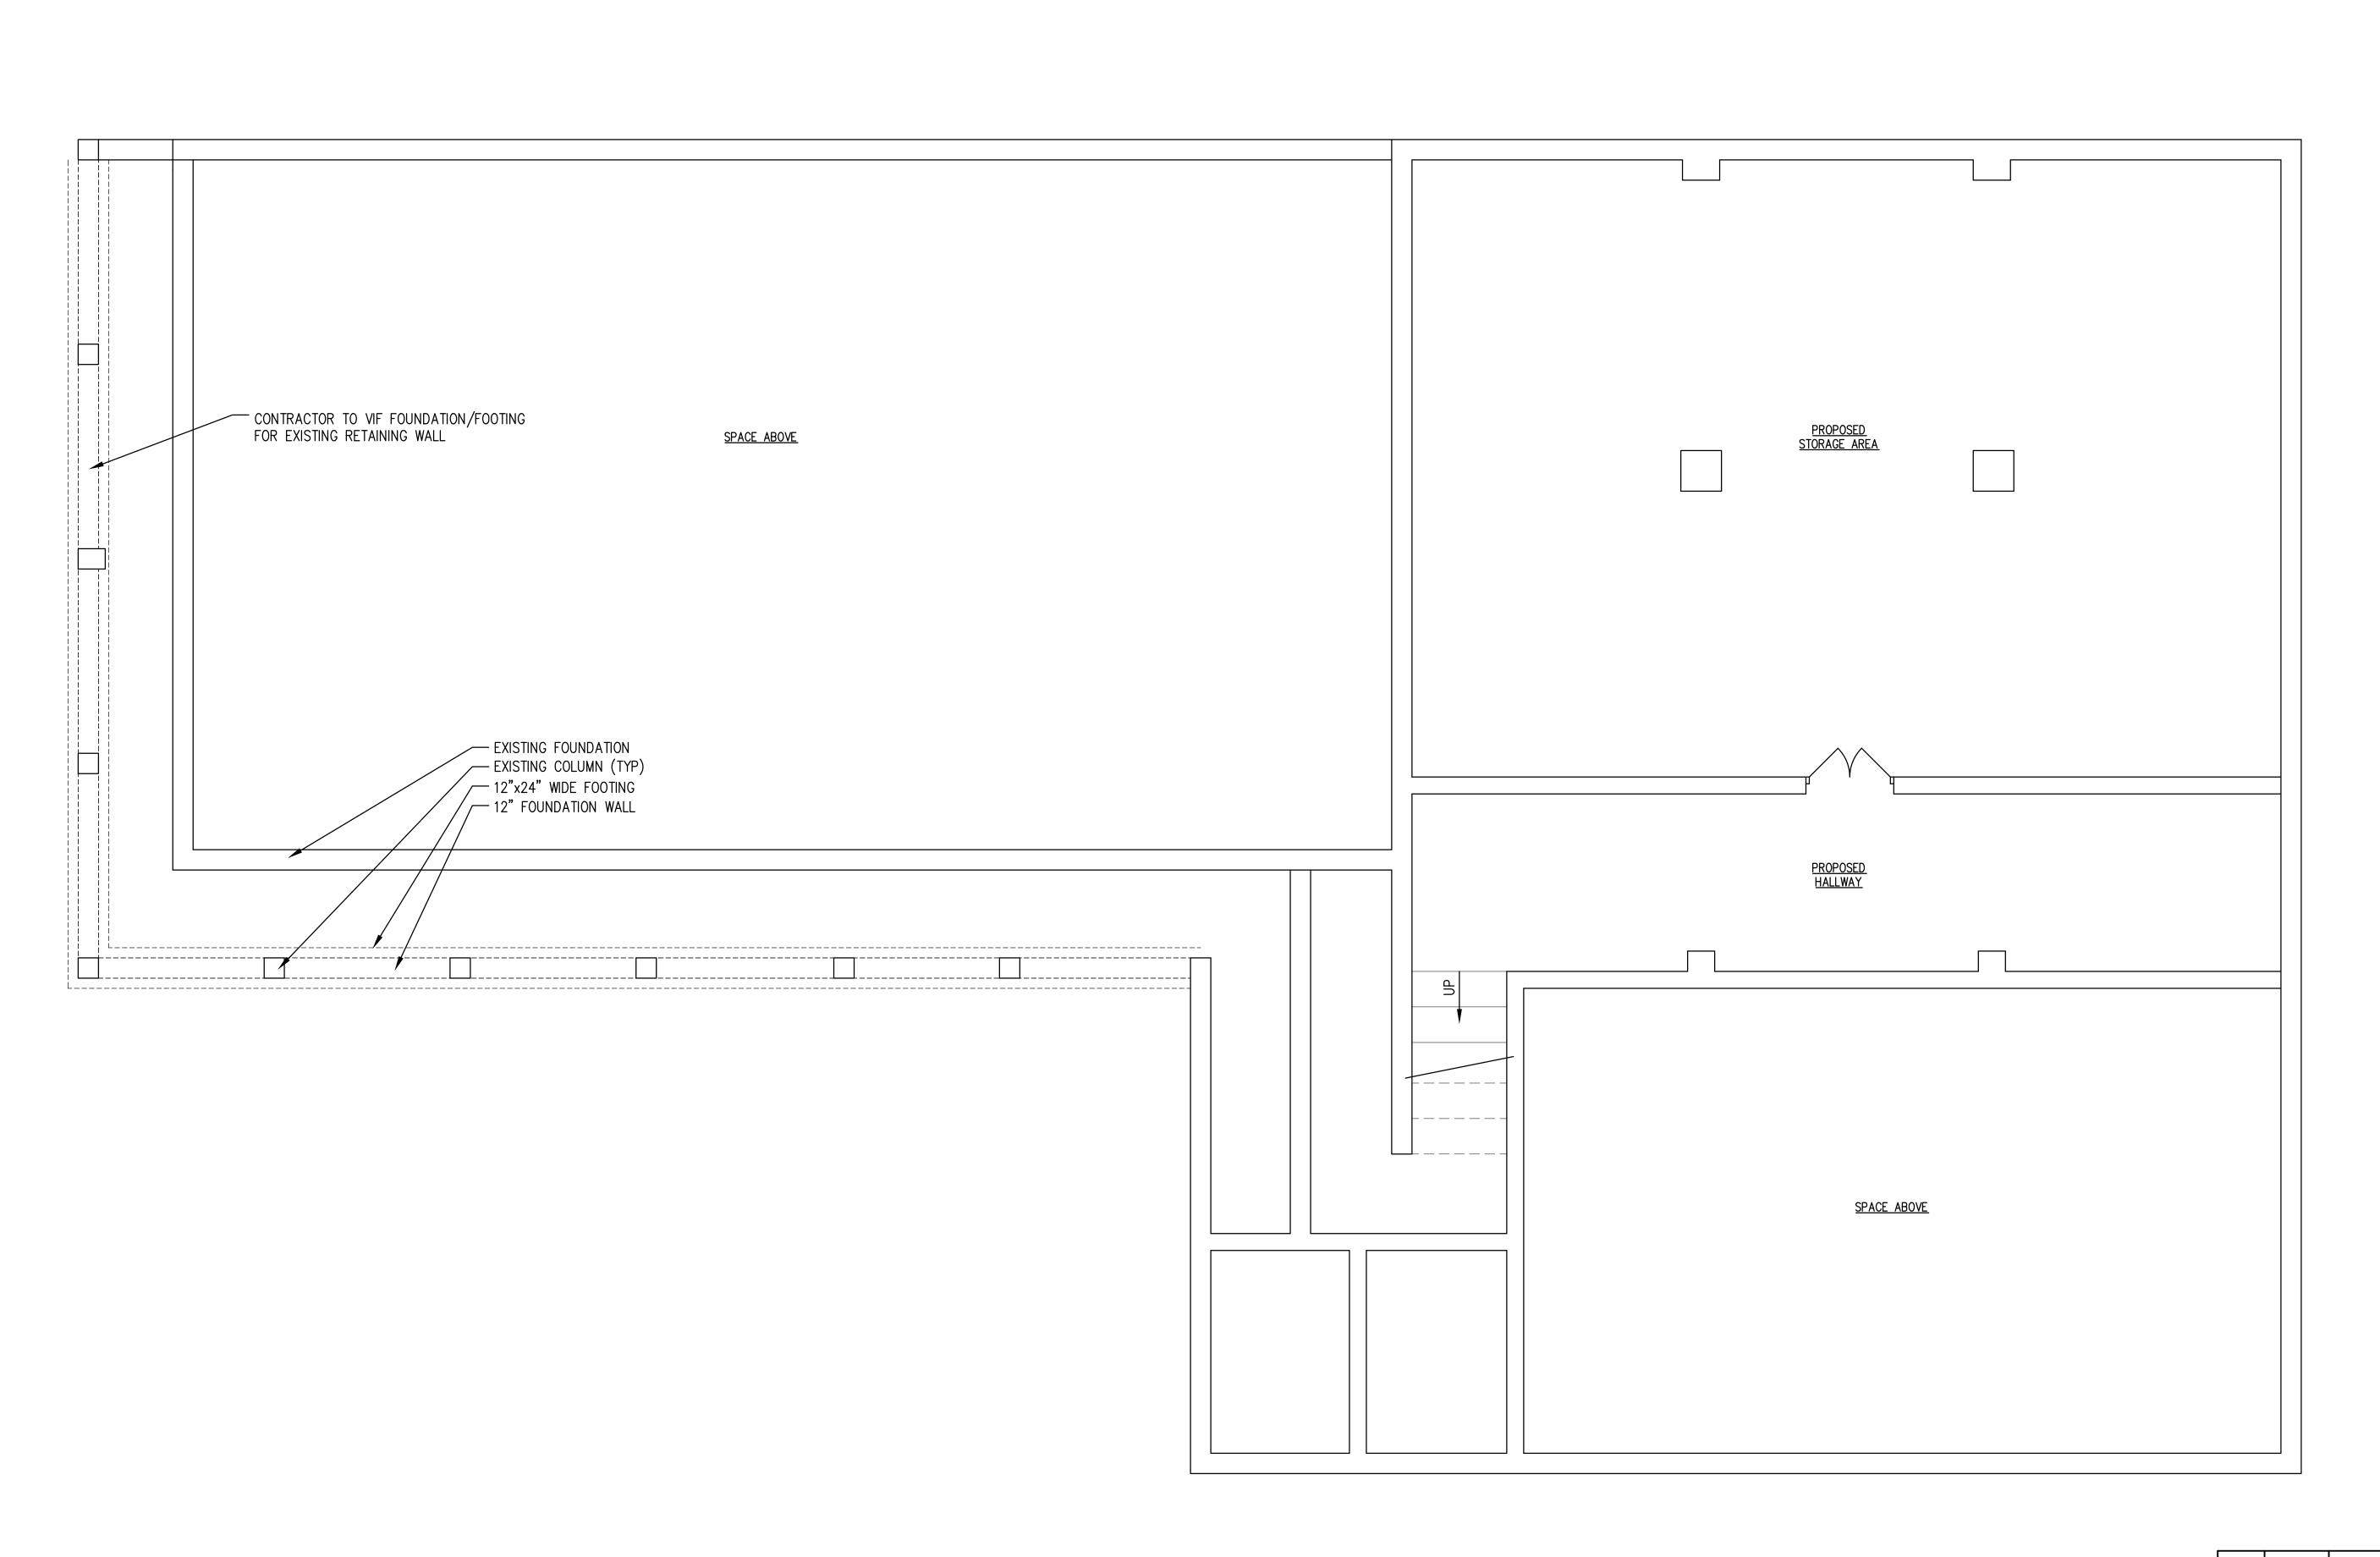

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DO NOT SCALE DRWAINGS


CHANGE OF USE - FIRST FLOOR
INTERIOR ALTERATIONS
Drawing Title
BASEMENT/FOUNDATION PLAN

Owner's Information
PROSPERO
134 MARBLE AVE
PLEASANTVILLE, NY

Original Date:
11/6/23
Project No:
23-50

A-1 of 5 Sheets

2 1/10/23 ISSUED TO PLANNING
1 12/10/23 ISSUED FOR REVIEW
No. Date Comments
REVISIONS

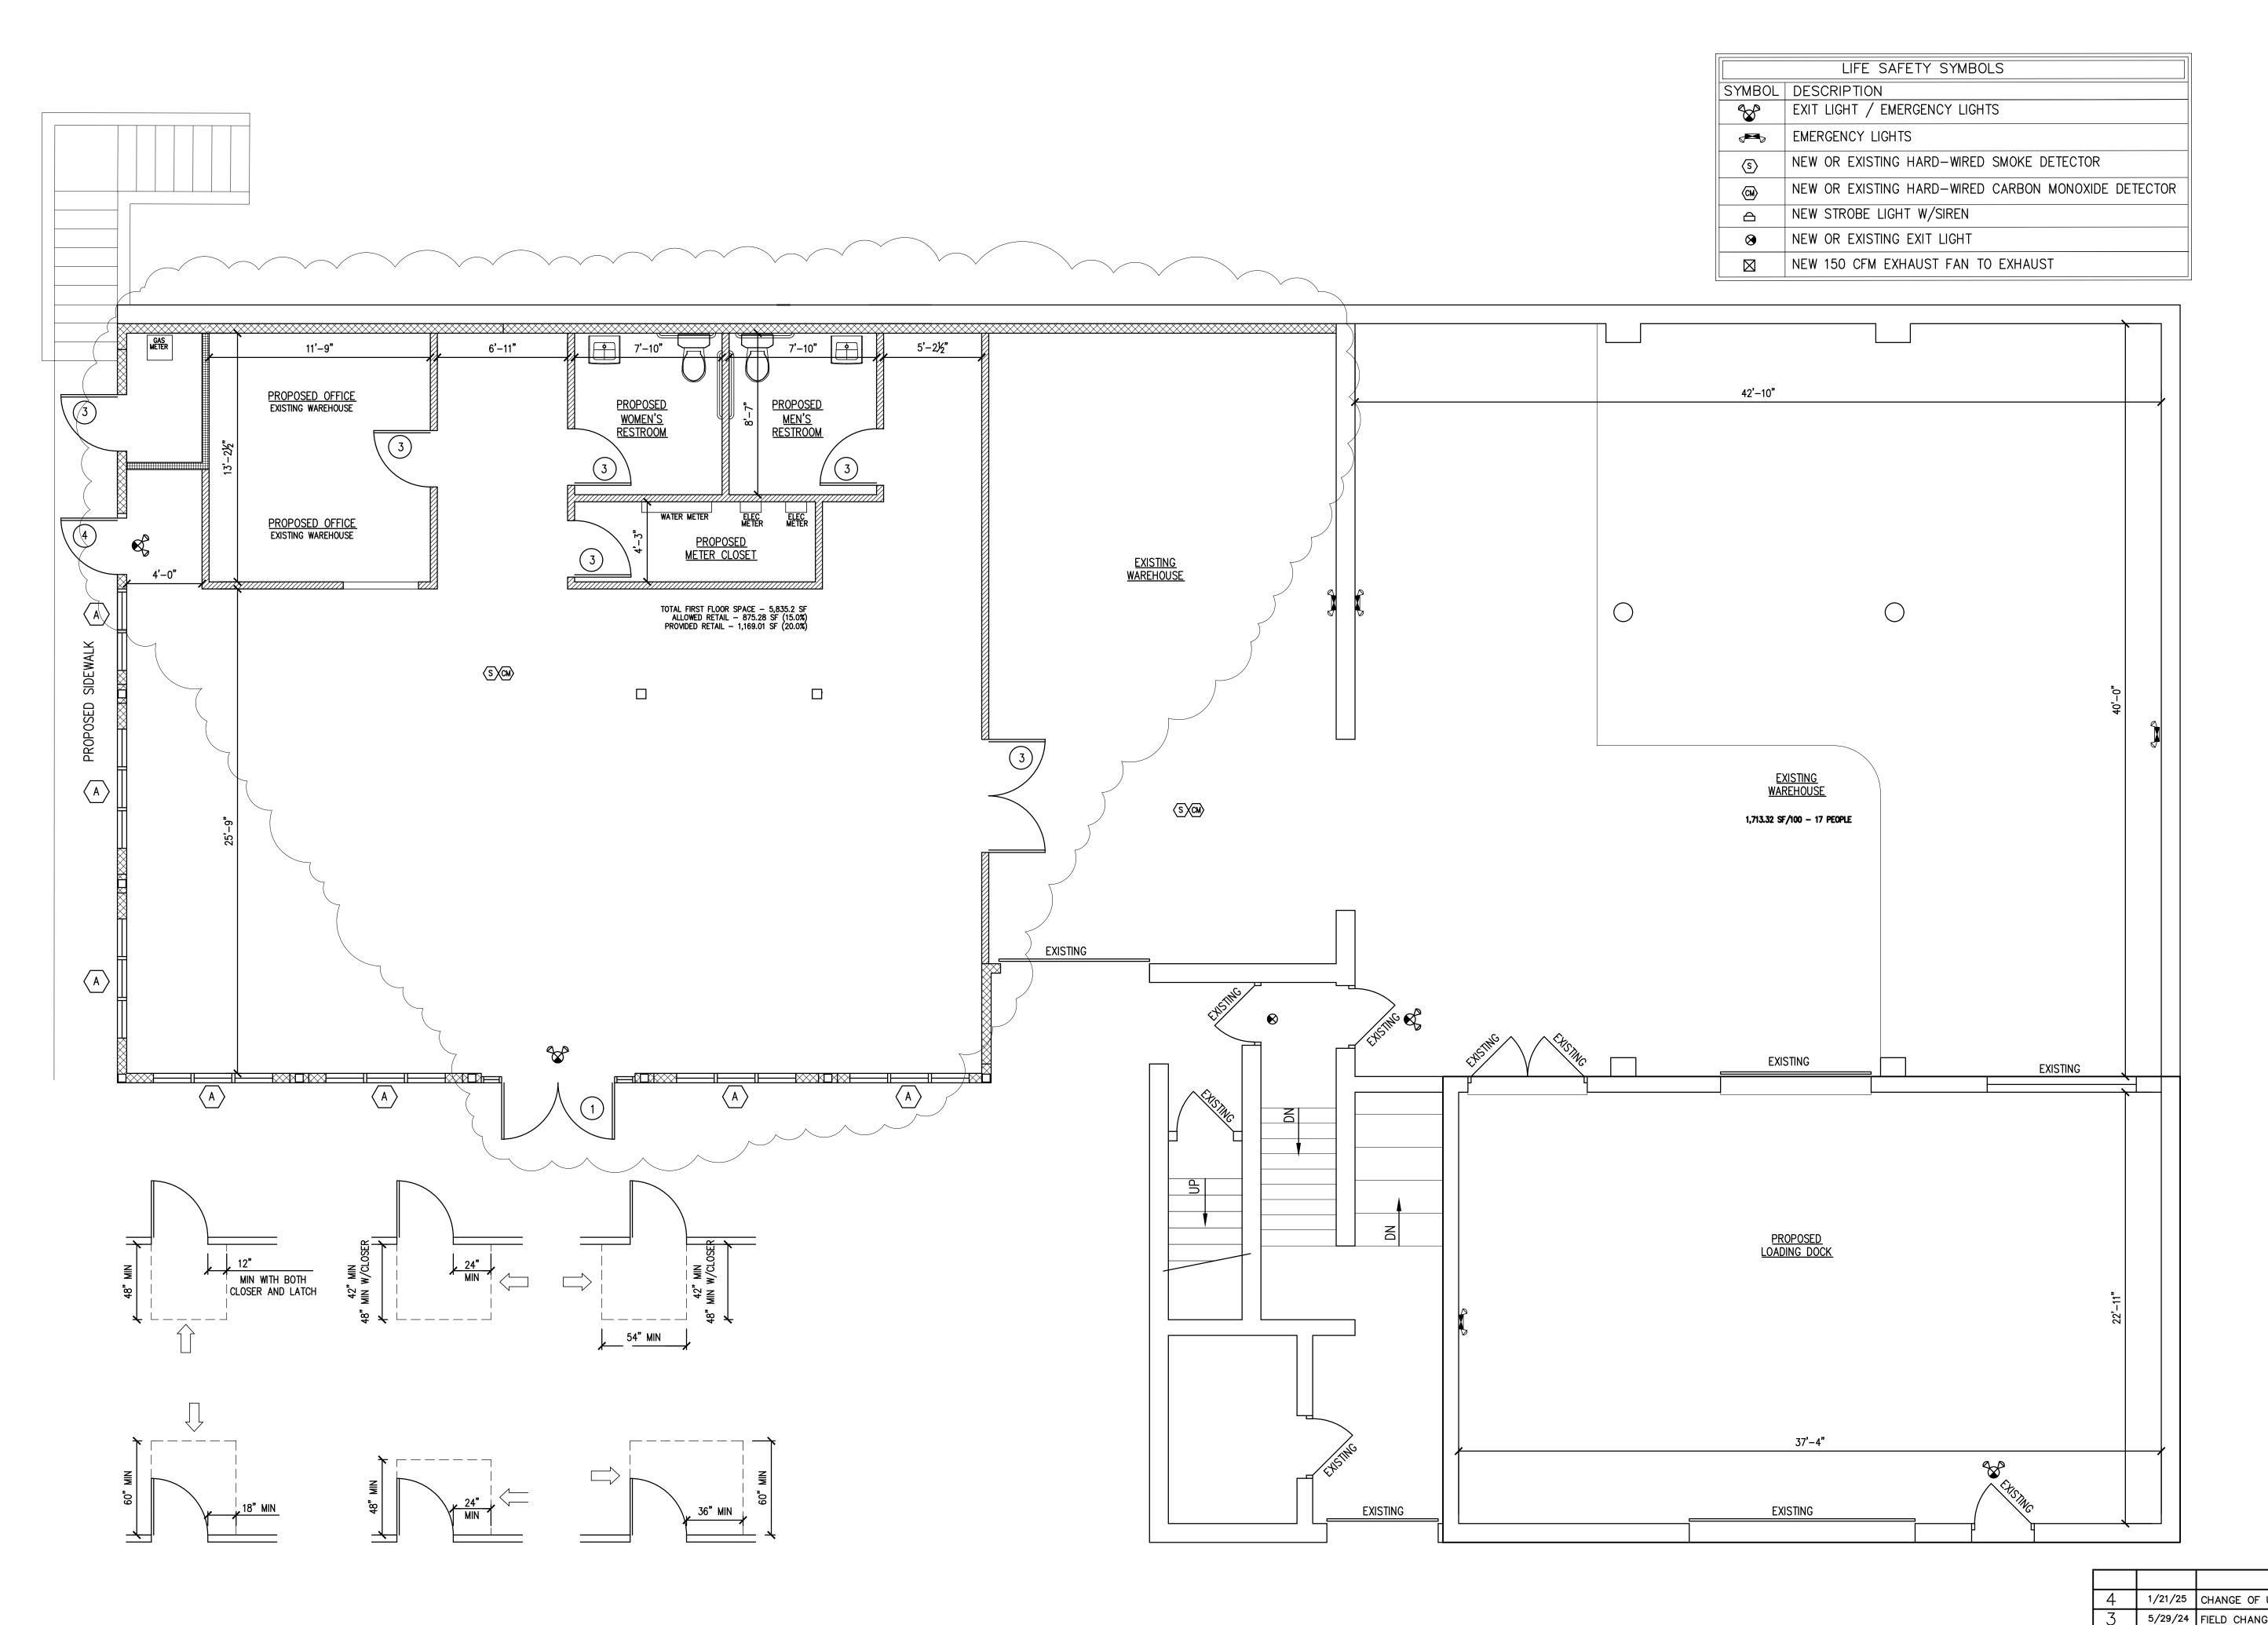

1/21/25 CHANGE OF USE
5/29/24 FIELD CHANGES PER OWNER
1/10/23 ISSUED TO PLANNING
12/10/23 ISSUED FOR REVIEW
O. Date Comments
REVISIONS

CHANGE OF USE - FIRST FLOOR
INTERIOR ALTERATIONS
Drawing Title
FIRST FLOOR CONSTRUCTION & LIFE
SAFETY PLAN

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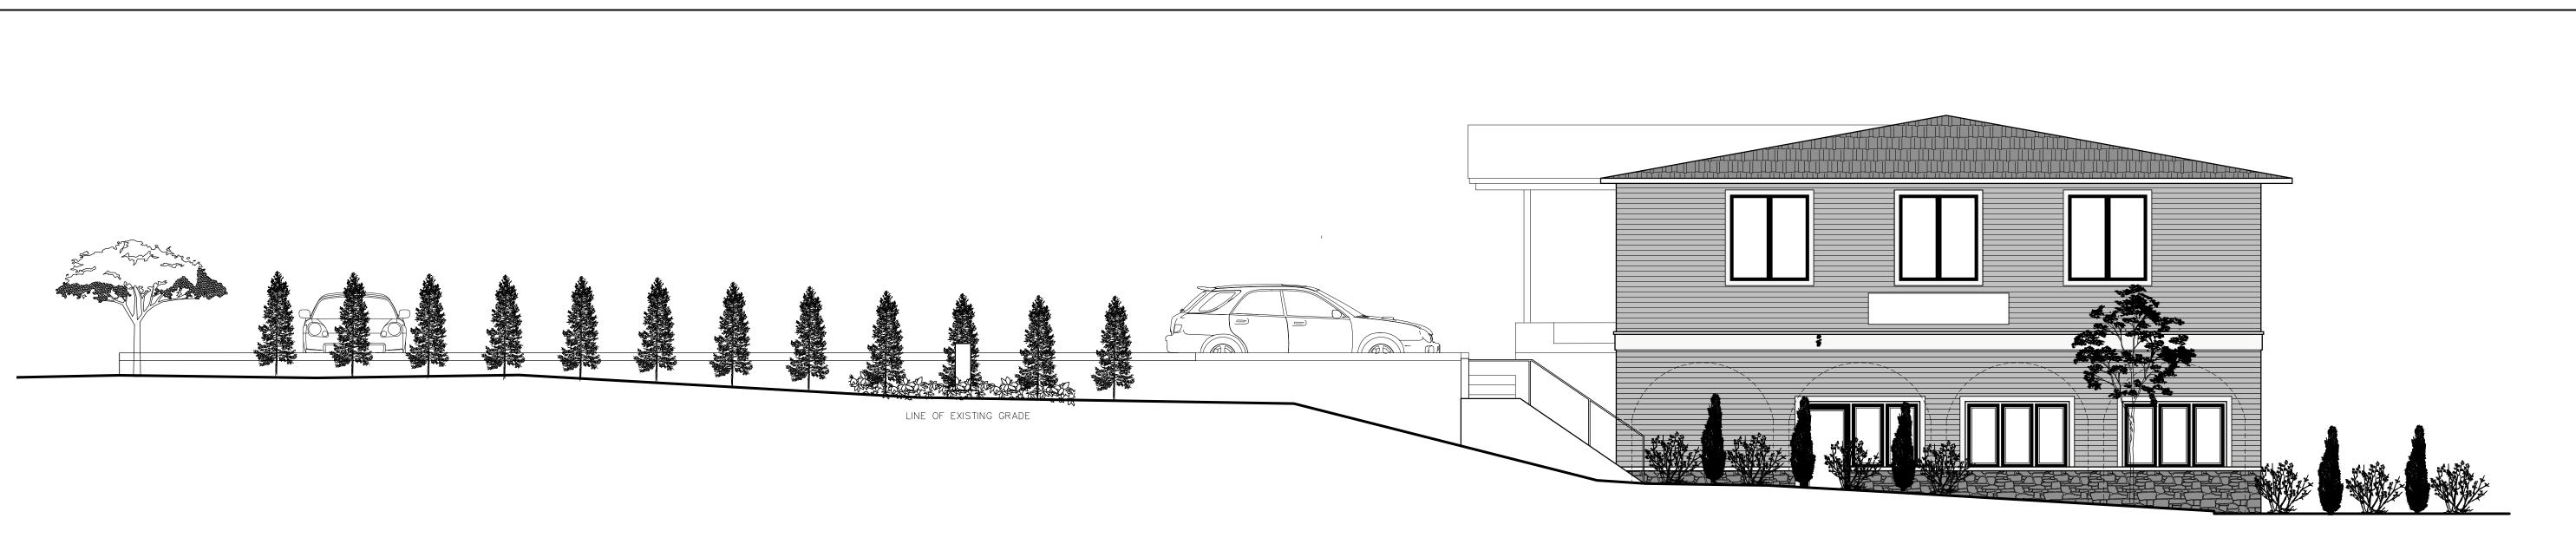
DO NOT SCALE DRWAINGS

Owner's Information
PROSPERO
134 MARBLE AVE
PLEASANTVILLE, NY

Original Date: 11/6/23 Project No:


A-2


1 FIRST FLOOR EGRESS PLAN A-2 SCALE 1/4" = 1'-0"





2 CASTLENTON STRRET ELEVATION
A-3 SCALE 3/16" = 1'-0"

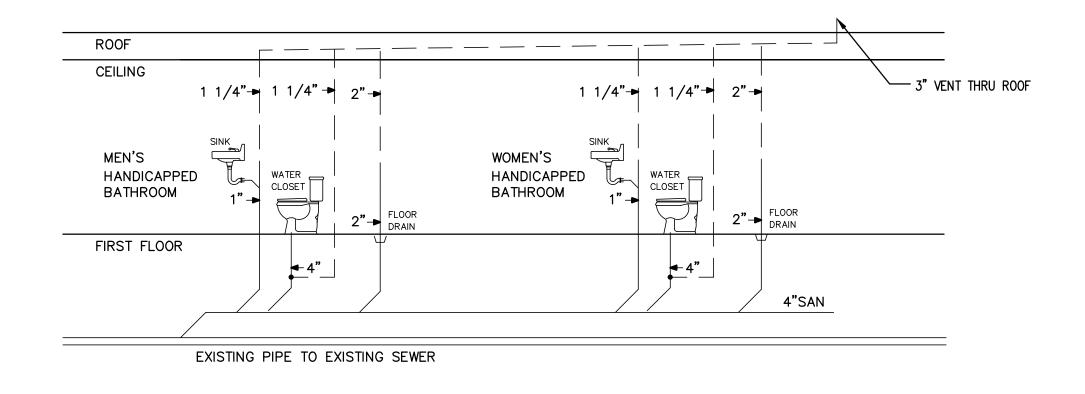

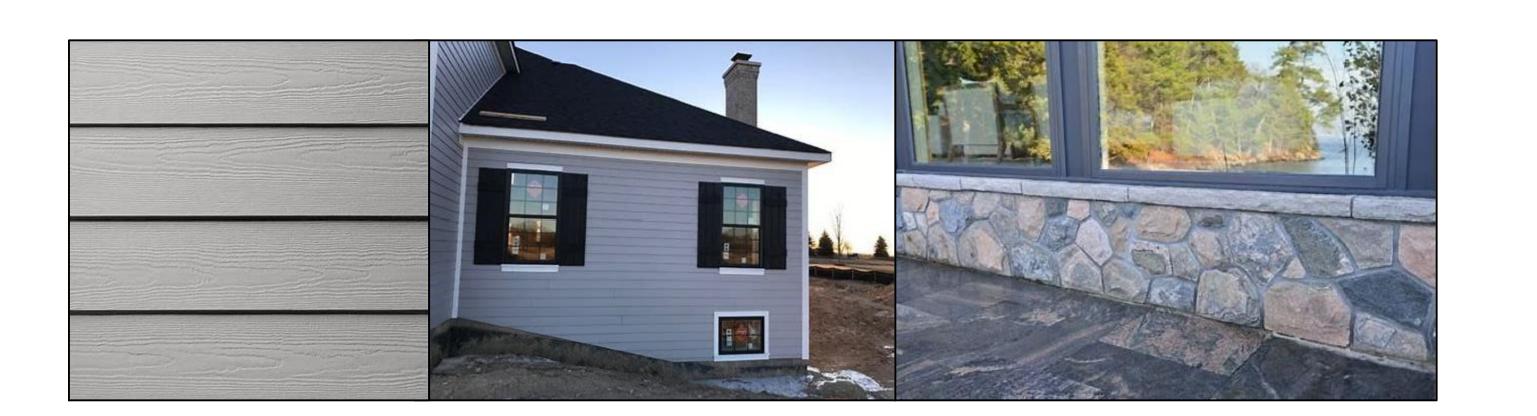

3 PLUMBER RISER DIAGRAM
A-3 SCALE NONE

3	2/21/24	PER PLANNING COMMENTS		
2	1/10/23	ISSUED TO PLANNING		
1	12/10/23	ISSUED FOR REVIEW		
No.	Date	Comments		
REVISIONS				


Owner's Information PROSPERO 134 MARBLE AVE PLEASANTVILLE, NY

CHANGE OF USE - FIRST INTERIOR ALTERATIONS

Drawing Title

ELEVATIONS AND DETAIL

Original Date: 11/6/23 Project No: 23-50

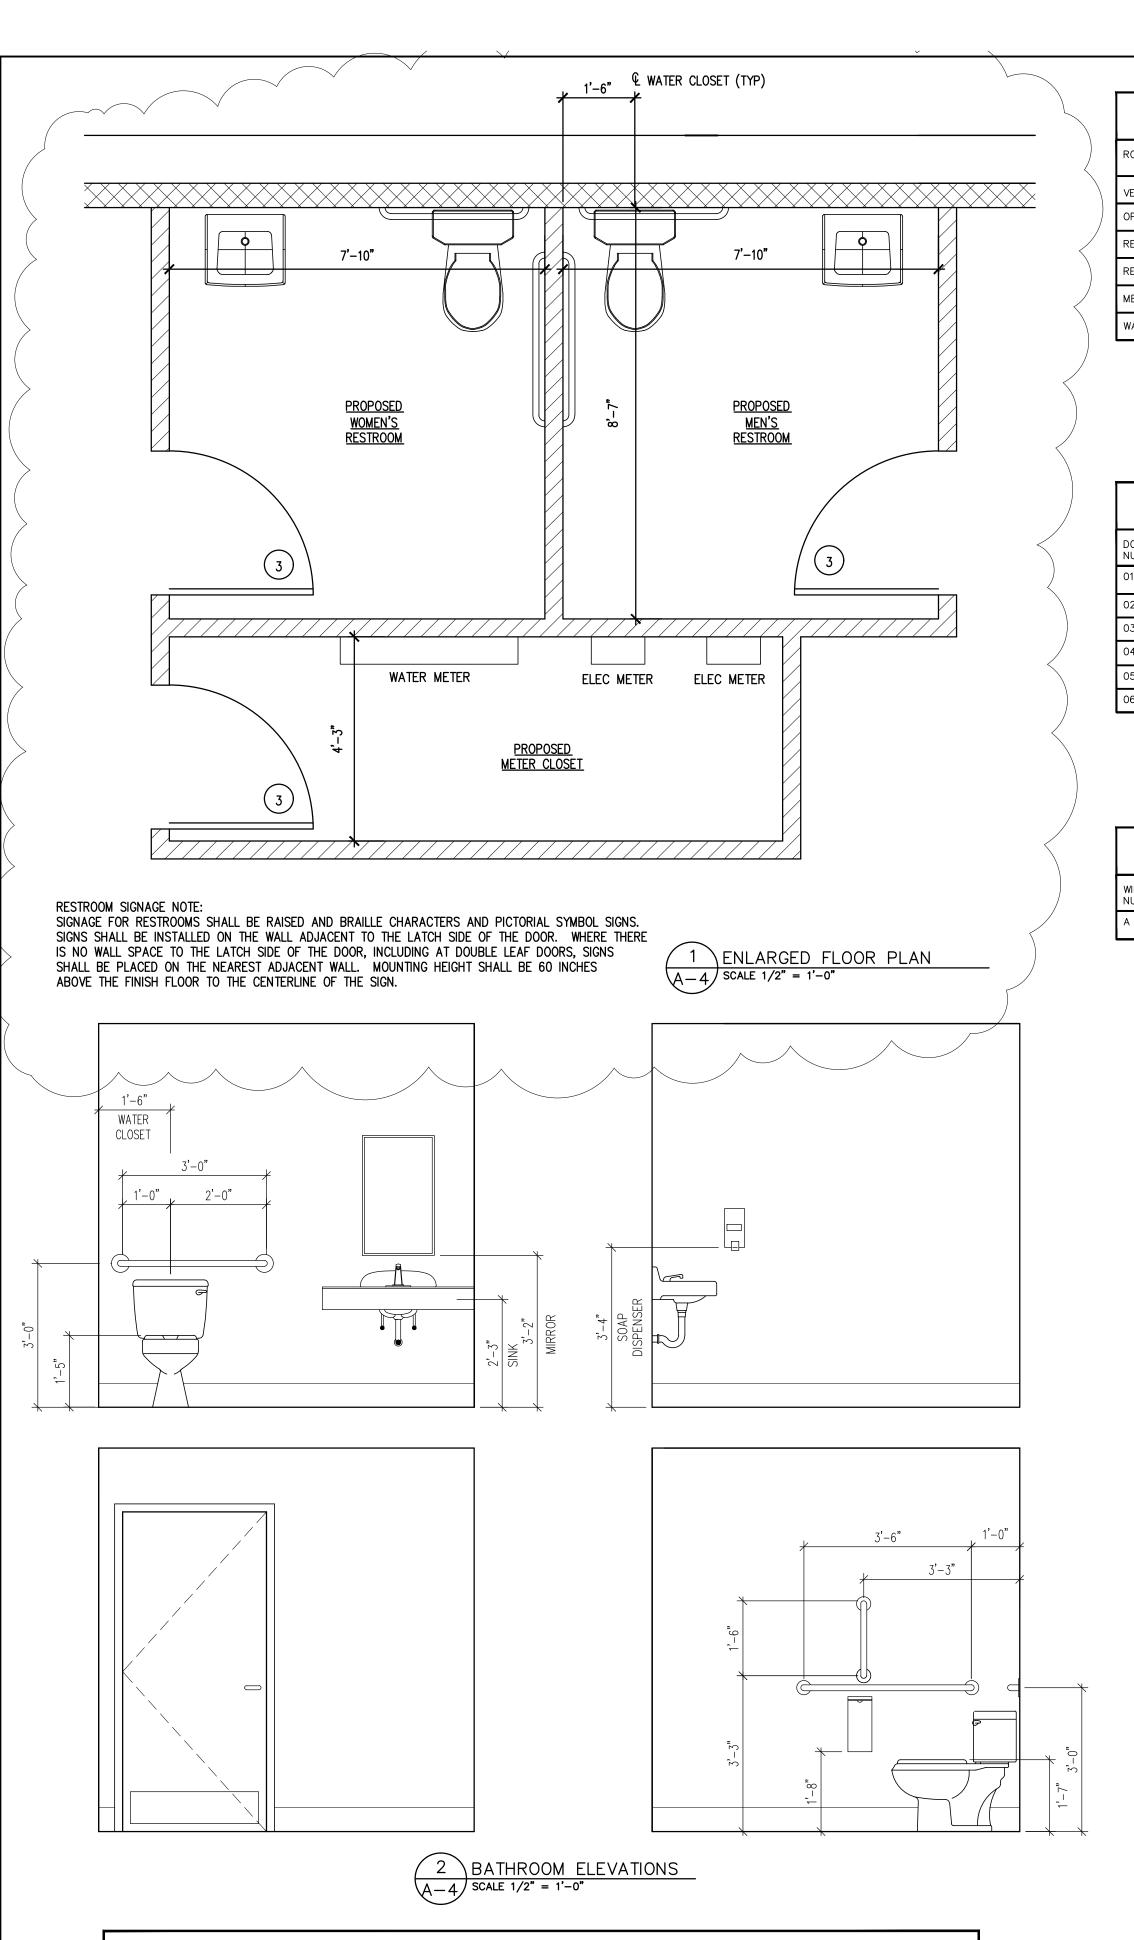

TOILET ACCESSOR SCHEDULE

MANUFACTURER/MODEL No.

BRADLEY - MODEL 781-1836

BRADLEY - SURFACE MOUNTED - MODEL 2494

BRADLEY - SURFACE MODEL - MODEL 5061

BRADLEY - SERIES #812, STAINLESS STEEL, 1 1/2" DIA

BRADLEY - SURFACE MOUNTED, TANK TYPE - VERTICAL - MODEL 6562

DESCRIPTION

GRAB BARS

18" x 36" MIRROR

LIQUID SOAP DISPENSER

PAPER TOWEL DISPENSER

TOILET PAPER DISPENSER

	FIN	I S	Н		S	\subset	<u> </u>	H E			J L E	-	
ROOM NAME	FLOOR FINISH	BASE	NORTH	H WALL	EAST	WALL	SOUTH	H WALL	WEST	WALL	CEILING	CROWN MOULDING/	REMARKS
			MAT.	FIN.	MAT.	FIN.	MAT.	FIN.	MAT.	FIN.	CEILING	CHAIR RAIL	REMARKS
VESTIBULE	TILE	PLASTIC	GYP.	PAINT	GYP.	PAINT	GYP.	PAINT	GYP.	PAINT	GYP.		GLASS STOREFRONT
OFFICE	TILE	PLASTIC	GYP.	PAINT	GYP.	PAINT	GYP.	PAINT	GYP.	PAINT	TILE		
RESTROOM	TILE	PLASTIC	GYP.	PAINT	GYP.	PAINT	GYP.	PAINT	GYP.	PAINT	TILE		
RESTROOM	TILE	PLASTIC	GYP.	PAINT	GYP.	PAINT	GYP.	PAINT	GYP.	PAINT	TILE		
MECH ROOM	EXISTING CONCRETE	NA	GYP.	PAINT	EX		EX		GYP.	PAINT	TILE		
WAREHOUSE	EXISTING CONCRETE	NA	EX		EX		EX		EX		EX		

FINISH SCHEDULE NOTES

- 1. ALL TILE OR STONE FLOORING TO BE SET ON THINSET
- ALL TILE, MARBLE SADDLES AND COUNERTOPS TO BE SUPPLIED BY OWNER AND INSTALLED BY CONTRACTOR.
- ALL INTERIOR DOORS PAINT GRADE SOLID CORE DOORS. INTERIOR DOOR AND WINDOW CASING TO BACKPRIMED AND PAINTED
- 4. ALL INTERIOR AND EXTERIOR CASING, TRIM, BASEBOARD TO MATCH EXISTING IN EVERY DETAIL

DOOR SCHEDULE							
DOOR NUMBER	DOOR OPENING (W x H xTHICKNESS)	MANUFACTURER / MODEL No.	DOOR TYPE	DOOR MATERIAL	FRAME MATERIAL	HARDWARE SET	REMARKS
01	(2) 3'-0" x 6'-8" x 1 3/8"	T.B.D.	DOUBLE	GLASS	METAL	ENTRY WITH KEY	ALUMINUM SADDLE IN BED OF MASTIC
02	(2) 3'-0" x 6'-8" x 1 3/8"	T.B.D.	DOUBLE	GLASS	METAL	ENTRY WITH KEY	ALUMINUM SADDLE IN BED OF MASTIC
03	3'-0" x 6'-8" x 1 3/8"	T.B.D.	SINGLE	FIBERGLASS	METAL	ENTRY WITH KEY	
04	3'-0" x 6'-8" x 1 3/8"	T.B.D.	SINGLE	GLASS	METAL	ENTRY WITH KEY	ALUMINUM SADDLE IN BED OF MASTIC
05	3'-0" x 6'-8" x 1 3/8"	T.B.D.	SINGLE	FIBERGLASS	METAL	ENTRY WITH KEY	ALUMINUM SADDLE IN BED OF MASTIC
06	3'-0" x 6'-8" x 1 3/8"	T.B.D.	SINGLE	FIBERGLASS	METAL	ENTRY WITH KEY	ALUMINUM SADDLE IN BED OF MASTIC

DOOR SCHEDULE NOTES

- ALL INTERIOR DOORS TO BE SOLID CORE PAINT GRADE, AS SCHEDULED. SEE SCHEDULE FOR SIZES.
- WHERE WEATHER-STRIPPING IS CALLED FOR, PROVIDE ON FOUR (4) SIDES, INCLUDING SADDLE.

1. ALL INSTALLTIONS TO BE COMPLIANCE WITH ALL ACCESSIBILITY CODES AND REGULATIONS.

3. PROVIDE BLOCKING IN WALLS AS REQUIRED TO ANCHOR FIXTURES.

7. CONTRACTOR TO FURNISH ALL TOILET ACCESSORIES AS SPECIFIED.

4. MAINTAIN INTEGRITY OF FIRE RATED WALLS BETWEEN TENANTS.

2. ALL EXPOSE HOT WATER & DRAIN PIPES TO BE INSULATED WITH "HANDI LAV-GUARD" INSULATION KIT BY TRUEBRO, INC.

5. APPLY § INT. GYPSUM BOARD ON WOOD OR METAL FURRING @ 24" O.C. TO CMU WALLS THAT OCCUR AT TOILET ROOMS.
6. PROVIDE STAINLESS STEEL ESCUTCHEON PLATES WHERE WATER & DRAIN LINE PENETRATE WALLS.

9. FLUSH CONTROLS SHALL BE INSTALLED AND SHALL NOT REQUIRE TIGHT GRASPING. PINCHING OR TWISTING OF THE WRIST.


8. CONTRACTOR PROVIDE FIRE TREATED 2x8 WOOD BLOCKING FOR ACCESSORIES AND FIRE TREATED DOUBLE 2x10 FOR LAVATORY.


CONTROLS FOR FLUSH VALVES SHALL BE MOUNTED ON THE WIDE SIDE OF TOILET AREAS NO MORE THAN 44" ABOVE THE FLOOR.

3. OWNER TO PROVIDE ALL DOOR LATCH/LOCK SETS. CONTRACTOR TO INSTALL ALL LATCH/LOCK SETS.

	WIND		S C	H E C) U L	E	
	WINDOW ROUGH OPENING (W x H xTHICKNESS)	MANUFACTURER / MODEL No.	WINDOW TYPE	INTERIOR CASING	EXTERIOR CASING	HARDWARE SET	REMARKS
А	(3) 2'-0 5/8" x 6'-0 3/8"	(3) C16 – ANDERSON	CASEMENT	MATCH EXISTING	MATCH EXISTING	MATCH EXISTING	BUG SCREEN


CONTRACTOR TO VIF HEIGHT OF WINDOW IN FIELD AND CONTACT ARCHITECT IF THERE IS A HEIGHT ISSUE.

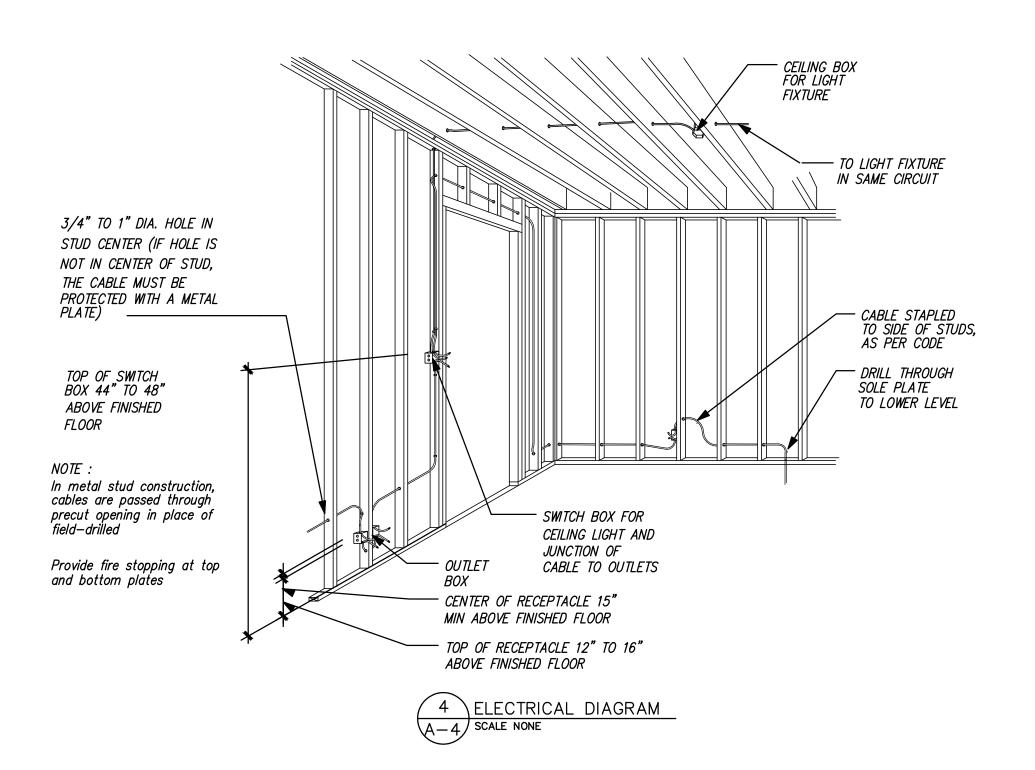

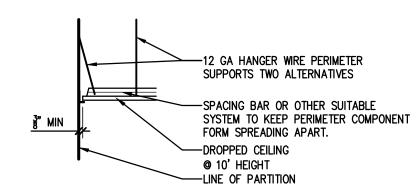

- NOTE:
 1. 12 GA HANGER WIRE ANCHORED TO STRUCTURE ABOVE
 AND HUNG VERTICALLY A MAX OF 8" FROM THE PERIMETER. 2. 12 GA HANGER WIRE ANCHORED TO PERIMETER WALL
- ATTACHMENT TO GRID MAY BE 8" FROM THE WALL, BUT THE WALL ATTACHMENT WIRE MUST NOT EXCEED A 1 / 16 SLOPE



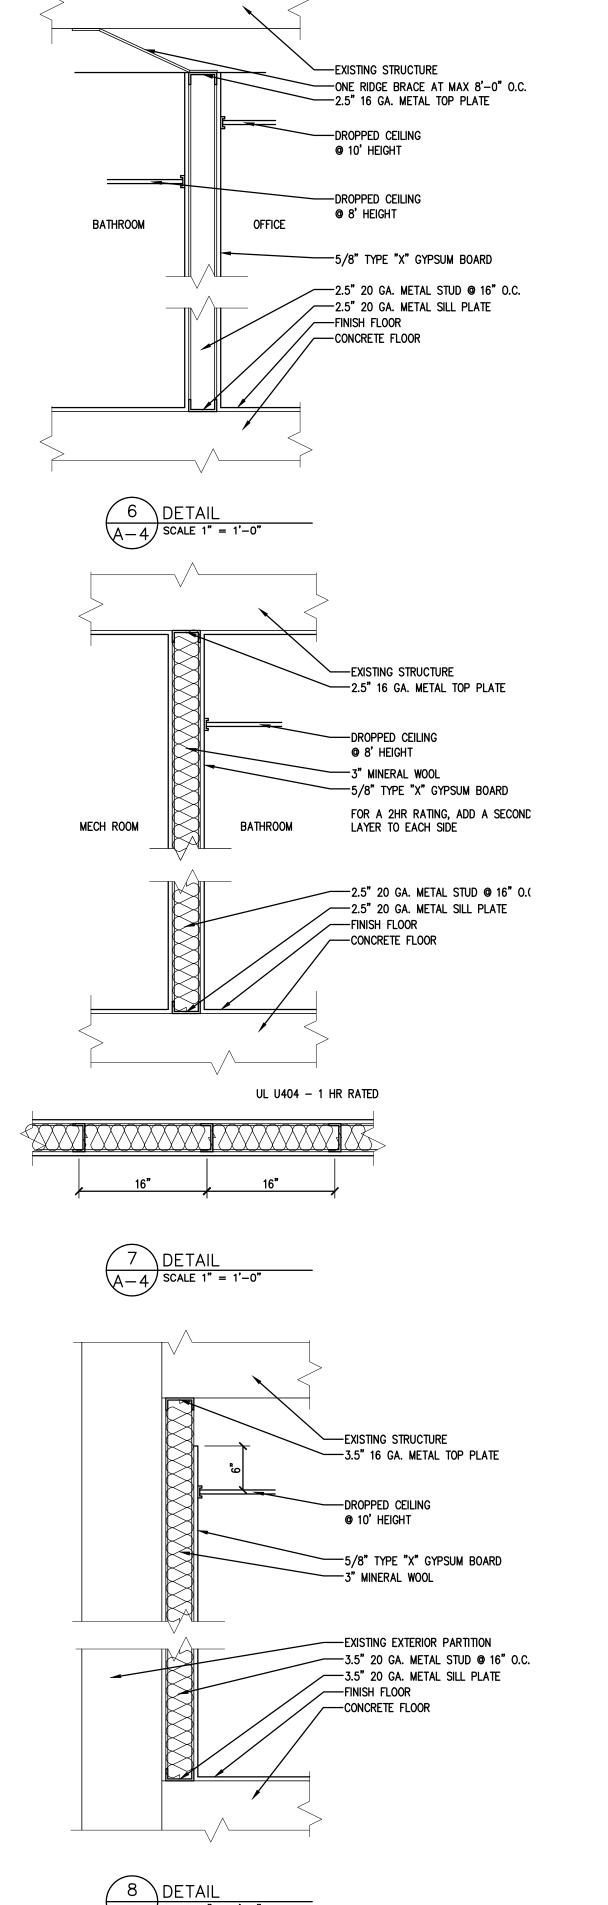

Owner's Information PROSPERO 134 MARBLE AVE PLEASANTVILLE, N

CHANGE OF USE - FIRST INTERIOR ALTERATION

Drawing Title

RESTROOM PLANS & ELEVA

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DO NOT SCALE DRWAINGS

Original Date: 11/6/23 Project No:

5/29/24 FIELD CHANGES PER OWNER

4 1/21/25 CHANGE OF USE

Date

1/10/23 ISSUED TO PLANNING

12/10/23 ISSUED FOR REVIEW

REVISIONS

Comments

GENERAL STRUCTURAL AND CONSTRUCTION NOTES

1.0 GENERAL

- 1. All work shall conform to the "2007 New York State Building Code" and to all other applicable Federal, State, and Local regulations.
- 2. In case of conflict between the General Notes and details, the most rigid requirements shall govern.
- 3. Work not indicated on a part of the drawings but reasonably implied to be similar to that shown at corresponding places shall be repeated.
- 4. Job site safety and construction procedures are the sole responsibility of the Contractor.
- 5. The Contractor shall provide for dewatering as required during excavation and construction.
- 6. The Contractor shall coordinate openings, sleeves, concrete housekeeping pads, inserts, and depressions shown on the Architectural, Structural, Mechanical, Electrical, and Plumbing Drawings.
- 7. See Architectural Drawings for locations of masonry and drywall non—load bearing partitions. Provide slip connections that allow vertical movement at the heads of all such partitions. Connections shall be designed to support the top of the walls laterally for the code—required lateral load.
- 8. All costs of investigation and/or redesign due to Contractor improper installation of structural elements or other items not in conformance with the Contract Documents shall be at the Contractor's expense.
- 9. The structural drawings shall be used in conjunction with the architectural and mechanical drawings. If there is a discrepancy between drawings, it is the Contractor's responsibility to notify the Architect prior to performing the work.
- 10. The Contractor shall verify all existing building information shown (dimensions, elevations, etc.) and notify the Architect/Engineer of any discrepancies prior to fabrication of any structural component.
- 11. The Contractor shall verify and/or establish all existing conditions and dimensions at the site. Failure to notify Architect/Engineer of unsatisfactory conditions constitutes acceptance of unsatisfactory conditions.
- 12. If the existing field conditions do not permit the installation of the work in accordance with the details shown, the Contractor shall notify the Architect/Engineer immediately and provide a sketch of the condition with his proposed modification of the details given on the Contract Documents. Do not commence work until condition is resolved and modification is approved by the Architect.
- 13. Where alterations involve existing supporting structure, the Contractor shall provide shoring and protection required to ensure the structural integrity of the existing structure.
- 14. The Contractor shall be responsible to determine allowable construction loads and to provide design and construction of falsework, formwork, stagings, bracing, sheeting, and shoring, etc.
- 15. Contractor to provide sheeting, bracing, and underpinning as necessary to prevent any lateral or vertical movements of adjacent existing buildings, streets, and any existing utility lines.
- 16. Bracing, sheeting, shoring, etc., required to insure the structural integrity of the existing buildings or new construction, sidewalks, utilities, etc., shall be designed by a Professional Engineer engaged by the Contractor. Detailed signed and sealed shop drawings shall be prepared indicating all work to be performed. Submit the shop drawings in accordance with the Contract requirements.
- 17. In no case shall heavy equipment be permitted closer than 8'-0" from any foundation wall. If it is necessary to operate such equipment closer than 8'-0" to the wall, the Contractor shall be the sole responsible party and, at his own expense, shall provide adequate supports or brace the wall to withstand the additional loads superimposed from such equipment.
- 18. No blasting shall be permitted without written approval.
- 19. The Contractor shall submit, for review, drawings and calculations for all performance assemblies identified in the General Notes and listed below: The design of these assemblies is the responsibility of the Contractor's Engineer registered in the Project's jurisdiction. All submittals shall bear this Engineer's seal and signature. Review shall be for general conformance with the project requirements as indicated on the Drawings and in the General Notes.
- A. Metal stairs and metal railings: Designs shall take into account all vertical and lateral loads required by applicable building codes.

 Where headers or other types of structural members have been designated by the Structural Engineer of Record to support the stairs, the connections from the stairs shall be designed so that no eccentric or torsional forces are induced in these structural members. The Contractor shall be responsible for furnishing and installing hardware as required by the stair design.
- 20. Shop drawings for all structural materials to be submitted to Architect for review prior to the start of fabrication or commencement of work. Review period shall be a minimum of two (2) weeks.
- 21. Reproduction of any portion of the Structural Contract Drawings for resubmittal as shop drawings is prohibited. Shop drawings produced in such a manner will be rejected and returned.
- 22. Shop drawings submitted for structural review shall consist of two (2) sets of prints and one (1) set of reproducibles. Only one (1) marked up set of reproducible with the Structural Engineer's comments will be returned to the Contractor.
- 23. Shop drawings shall bear the Contractor's stamp of approval which shall constitute certification that the Contractor has verified all construction criteria, materials, and similar data and has checked each drawing for completeness, coordination, and compliance with the Contract Documents.
- 24. The shop drawings shall include dimensioned floor and roof edges, openings and sleeves at all floors required for all trades.
- 25. The drawings have been produced entirely on MPP Engineers LLC Cadd System. Any other lettering, lines or symbols, other than professional stamps and signatures, have been made without the authorization of MPP Engineers LLC are invalid.
- 26. The structural drawings shall govern the work for all structural features, unless noted otherwise. The architectural drawings shall govern the work for all dimensions.
- 27. Submit periodic reports within one business day after receipt by the Contractor to Architect/Engineer and the construction code official during construction. Submit final inspection report summary for each division of work, certified by a licensed professional Engineer, that inspections were performed and that work was performed in accordance with Contract Documents.
- 28. The Owner shall engage a testing agency to provide testing services as indicated in each section of these General Notes.
- 29. All materials shall be stored to protect them from exposure to the elements.

2.0 EARTHWORK

- 1. Engineered (controlled compacted) fill within the building area shall be constructed prior to footing (or pile cap) excavation.
- 2. Excavation shall be performed so as not to disturb existing adjacent buildings, streets, and utility lines. Verify location of all utilities prior to commencement of work. Hand excavate around utilities as required.
- 3. See the specifications and geotechnical report for excavation, backfill and preparation of the foundation and slab—on—grade subgrade, including compaction requirements.
- 4. Satisfactory fill materials are those complying with ASTM D2487, groups GW, GP, GM, SM, SW, and SP. On site borrow material shall be tested to determine suitability for use as fill material.
- 5. Compact soil to not less than the following percentages of maximum density of modified proctor (ASTM D1557):
- Under building foundations 98%
- Under building slabs, steps, pavements 95%
- 6. Remove existing vegetation, topsoil, and unsatisfactory soil materials. Proof roll subgrade to obtain uniformly densified substrata prior to placing fill material evenly in 8" thick (maximum) layers and compacting to required density.
- 7. Backfill shall be brought up simultaneously on each side of walls with a grade difference not to exceed 2'-0" at any time.
- 8. Do not backfill against basement walls until basement slab on grade and all framed slabs are in place and have attained the specified design strength. Provide temporary shoring where required.

3.0 FOUNDATIONS

- 1. Foundations have been designed for an allowable bearing capacity and footing elevations established based upon adjacent building information, known information from adjacent sites, and similar soil conditions in the project vicinity. A new Subsurface Investigation Report, with foundation recommendations, has not been provided by the Owner for this project at this time. The soil information and bearing capacity shall be verified by a qualified Geotechnical Engineer during construction.
- 2. Footings shall bear on undisturbed stratum or engineered fill with a minimum bearing capacity of 3,000 psf.
- 3. Prior to footing concrete placement, the footing subgrade shall be approved by the inspecting Geotechnical Engineer. If conditions prove to be unacceptable at elevations shown, footing bottoms shall be lowered to acceptable subgrade material. Fill over—excavation with lean concrete (2,500 psi).
- 4. The bottom of exterior footings shall be a minimum of three (3) feet below finished grade, or as required by Local building codes.
- 5. The bearing elevations of new footings adjacent to existing footings are to match the adjacent existing footing bearing elevations unless indicated otherwise on plans. If adjacent existing footings are higher than the new, then the existing footings shall be underpinned so that the bearing elevation of the underpinning matches the new footing elevation.
- 6. Slabs on grade shall bear on mechanically compacted soil capable of supporting 150 psf. Drainage fill under slabs shall be compacted
- 7. Concrete for foundations shall be poured on the same day the subgrade is approved by the Geotechnical Engineer.
- 8. Utility lines shall not be placed through or below foundations without the Structural Engineer's approval.
- 9. Provide a continuous waterstop at all horizontal and vertical construction joints in the elevator pit and all other pit walls.
- 10. The Contractor shall observe water conditions at the site and take the necessary precautions to ensure that the foundation excavations remain dry during construction. Any sheeting or shoring required for dewatering shall be the responsibility of the Contractor.
- 11. The Contractor shall be responsible for coordinating the need to use foundation rebar as a grounding electrode system and shall be responsible for installing the bonding clamp prior to placement of the concrete.

4.0 CAST-IN-PLACE CONCRETE

- 1. Concrete shall be designed and detailed in accordance with the Building Code Requirements for Structural Concrete (ACI—318—05), and constructed in accordance with the CRSI Manual of Standard Practice.
- 2. Concrete for slabs shall have a minimum compressive 28—day strength of 4,000 psi; all other concrete shall be 3,000 psi. Air Entrainment 4% to 6% in all exposed concrete work.
- 3. Maximum water/cement ratios:
 - A. Foundations 0.50
 B. Interior Slabs 0.47
- B. Interior Slabs 0.47 C. Exterior Slabs 0.44
- 4. All concrete shall be normal weight concrete (144 pcf +) with all cement conforming to ASTM C150, Type I. Maximum aggregate size shall be $1-\frac{1}{2}$ " for footings and $\frac{3}{4}$ " for walls and slabs, conforming to ASTM C33.
- 5. Reinforcing steel: ASTM A615 Grade 60.
- 6. Welded Wire Reinforcement: (WWR) ASTM A-185.
- 7. Leveling Grout shall be non-shrink, non-metallic type, factory pre-mixed grout in accordance with CE-CRD-C621 or ASTM C109, with a minimum compressive 28-day strength of 5,000 psi.
- 8. Reinforcing steel clear cover shall be as follows unless noted otherwise:
- A. Concrete cast against and permanently exposed to earth
 B. Concrete exposed to earth or weather
- #6 bars and larger 2" #5 bars and smaller $1-\frac{1}{2}$ "
- C. Concrete not exposed to weather or in contact with ground

 Slabs, walls, joists

 #11 bars and smaller

 34"
- 9. Submit to Architect/Engineer reinforcing steel shop drawings for approval and mix designs for review prior to placing any concrete.
- 10. All reinforcement shall be securely held in place while placing concrete. If required, additional bars, stirrups or chairs shall be provided by the Contractor to furnish support for all bars.
- 11. Lap welded wire reinforcement two (2) full wire spaces at splices and wire together.
- 12. Provide plastic tipped bolsters and chairs at all locations where the concrete surface in contact with the bolsters or chairs is exposed.
- 13. Placing of concrete shall not start until the placement of reinforcing has been approved by the Inspection Agency.
- 14 Ronding agent shall be used where new concrete is placed against existing concre
- 14. Bonding agent shall be used where new concrete is placed against existing concrete.15. Epoxy adhesive shall be used where dowels are to be installed into existing concrete. Submit manufacturer information for engineer review.
- 16. No sleeve shall be placed through any concrete element unless shown on the approved shop drawings or specifically authorized in writing by the Structural Engineer. The Contractor shall verify dimensions and locations of all slots, pipe sleeves, etc. as required for mechanical trades before concrete is placed.
- 17. Pipes or conduits placed in slabs shall not have an outside diameter larger than ½ the slab thickness and shall not be spaced closer than 3 diameters on center. Aluminum conduits shall not be placed in concrete. No conduits shall be placed in slabs within 12 inches of column face or face of bearing wall. No conduits may be placed in exterior slabs or slabs subjected to fluids.
- 18. Prior to placing concrete, the Contractor shall submit for review by the structural engineer, a concrete pour schedule showing location of all proposed construction joints and waterstops.
- 19. Prior to concrete placement, the Contractor shall submit to the structural engineer for review, concrete mix designs prepared in accordance with the specifications and requirements indicated in the general notes.
- 20. Concrete shall not be pumped through aluminum pipes and shall not be placed in contact with aluminum forms, mixing drums, buggies, chutes, conveyors or other equipment made of aluminum.
- 21. All inserts and sleeves shall be cast—in—place whenever feasible. Drilled or powder driven fasteners will be permitted when proven to the satisfaction of the Structural Engineer that the fasteners will not spall the concrete and have the same capacity as cast—in—place inserts.
- reinforcing and destruction of concrete. Holes shall be blown clean prior to placing bolts or adhesive anchors.

 23. Chamfer all exposed concrete corners unless noted otherwise on Architectural Drawings.
- 24. The concrete slabs shall be finished flat and level within tolerance, to the elevation indicated on the drawings.
- 25. Early drying out of concrete, especially during the first 24 hours, shall be carefully guarded against. All surfaces shall be moist cured or protected using a membrane curing agent applied as soon as forms are removed. If membrane curing agent is used, exercise care not to
- 26. Cold weather concreting shall be in accordance with ACI-306. Hot weather concreting shall be in accordance with ACI-305R.

22. When installing expansion bolts or adhesive anchors, the Contractor shall take measures to avoid drilling or cutting of any existing

- 27. Throughout construction, the concrete work shall be adequately protected against damage due to excessive loading, construction equipment, materials or methods, ice, rain, snow, excessive heat, and freezing temperatures.
- 28. Prepare concrete test cylinders from each day's pour. Cylinders shall be properly cured and stored. Sample fresh concrete in accordance with ASTM C172.
- 29. Retain laboratory to provide testing service. Slump per ASTM C143I air content per ASTM C231 or C173, cylinder tests per ASTM C31 and C39. One set of six (6) cylinders for each 50 cubic yards for each mix used. Reports of all tests to be submitted to the Architect.

5.0 MASONRY

- 1. Masonry has been designed in accordance with the Building Code Requirements for Masonry Structures (ACI 530-05/ASCE 5-05) and shall be constructed in accordance with the Specifications for Masonry Structures (ACI 530.1-05/ASCE 6-05), except where otherwise modified by these General Notes and Specifications.
- 2. Mortar shall conform to ASTM C270, Type M or S. All Portland cement shall conform to ASTM C150, Type I. Lime shall conform to ASTM C207 and masonry cement shall conform to ASTM C91.
- 3. Grout shall conform to ASTM C476 and shall have a minimum 28 day compressive strength of 3000 psi. Slump of grout shall be 8 to 10 inches and the maximum aggregate size shall be \(\frac{3}{8} \) (aggregate graded to produce fine grout in conformance with ASTM C476 and C404)
- 4. Concrete Block Units:
 - A. Solid and hollow load bearing units per ASTM C90, Type N-1, as required to provide 28 day compressive strength, f'm as noted below
- 5. Minimum 28-day compressive strength of masonry, f'm shall be 1,500 psi, unless noted otherwise.
- 6. Full bed and head joints shall be provided.
- 7. Horizontal Joint Reinforcing: ASTM A82; 9—gage truss—type, galvanized.
- 8. Deformed bar reinforcement shall conform to ASTM A615, Grade 60 and shall be full height of walls unless otherwise noted. Provide bar spacers and positioners as required to properly locate and stabilize reinforcing during grouting operations. Grout all reinforced cells solid with grout.
- 9. Hollow concrete units below grade and slab on grade shall be normal weight and have all cells grouted solid.
- Provide and install temporary bracing required insuring stability of all walls during construction and until erection of attached structural framing is completed.
- 11. Provide galvanized horizontal joint reinforcement in all walls and partitions at 16" o.c. unless otherwise shown or noted. Provide one (1) piece prefabricated units at 8" o.c. at all wall corners and intersections.
- 12. Lap splices for deformed reinforcing bars used in masonry construction shall be 50 bar diameters.
- 13. Submit grout mix design and masonry unit certifications to the Architect for review
- 14. Grout placement shall not start until the placement of reinforcing has been approved by the Inspection Agency.
- 15. Fill all cells in top two courses below finished floor, CMU lintels, bond beams, and beam bearings and cells with reinforcement full height solid with grout.
- 16. Allow grout in reinforced CMU walls to cure a minimum of 48 hours before imposing concentrated or other loads from above.
- 17. Provide masonry anchors set on coursing and attached to all beams at 32" o.c. horizontal, columns at 24" o.c. vertical, partitions and walls at 16" o.c at all beams, columns, partitions and walls abutting or embedded in masonry unless noted otherwise on Architectural and Structural drawings.
- 18. Provide bond beams with two (2) #5 horizontal reinforcement continuous in all masonry walls at each framing level. Provide a minimum of two (2) #5 bars at the ends of all walls and on each side of each opening.
- 19. All piers and partitions shall be bonded or anchored to adjacent masonry walls. Provide ties to adjacent floor and roof construction in accordance with details on drawings.
- 20. The Contractor shall verify all openings below lintels indicated are adequate to accept doorframes, louvers, etc. as shown on the Architectural and Mechanical Drawings. Notify the Architect and Structural Engineer of any discrepancies prior to lintel installation.
- 21. No openings shall be placed above any lintel within a height less than or equal to the width of the clear opening below the lintel, unless specifically shown or approved by the Structural Engineer.
- 22. All masonry work to be executed in cold weather shall be in conformance with the recommendations for cold weather construction found in the Building Code Requirements for Masonry Structures (ACI 530-05/ASCE 5-05) and shall be constructed in accordance with the Specifications for Masonry Structures (ACI 530.1-05/ASCE 6-05) with the following additions: For all conditions when temperatures fall below 40 degrees F, the temperature of the newly laid masonry or newly grouted masonry shall be maintained above 32 degrees F for a minimum of 24 hours using the methods described in ACI 530.1.
- 23. The Testing and Inspection Agency shall monitor the proportioning, mixing, and consistency of mortar and grout; the placement of mortar, grout, and masonry units; and the placement of reinforcing steel for compliance with the Contract Documents.
- 24. All wall sections and piers less than two square feet in cross—sectional area shall be fully grouted.
- 25. Provide vertical masonry control joints at maximum 25'-0" on center unless detailed on Architectural drawings, coordinate locations with

6.0 STRUCTURAL STEEL

- 1. Fabrication and erection of structural steel shall conform to the "Steel Construction Manual", Thirteenth Edition, 2005, American Institute of Steel Construction including Specifications for Structural Steel Buildings, Specification for Structural Joints Using ASTM A325 or A490 Bolts, and AISC Code of Standard Practice except Sections 4.2 and 7.9 which shall not be applicable to this project.
- 2. All welding shall be performed by certified welders and shall conform to "Structural Welding Code ANSI/AWS D1.1—92", American Welding Society.
- 3. Wide flange shapes:

 ASTM A992 or A572, Grade 50.

 4. Structural shapes & plates:

 ASTM A36, A572 or A992.
- 5. Steel pipe: ASTM A53, GRADE B.
- 6. Steel tubing (square, rect. or round): ASTM A500, Grade B.7. Galvanized structural steel:
- A. Structural shapes and rods ASTM A123.
- A. Structural snapes and roas

 B. Bolts, fasteners and hardware

 ASTM A153.
- B. Bolts, fasteners and hardware ASIM A153.

 9. All bolted connections shall be with ASTM A325 high strength bolts ¾" minimum diameter, unless noted otherwise.
- 10. All bolted connections on wind bracing members and columns shall be slip critical connections.
- 11. Anchor rods shall conform to ASTM F1554, Grade 36, unless noted otherwise.
- 12. Welding electrodes shall be E70XX for manual arc welding and F7X—EXXX for submerged arc welding. All welders shall be certified by the AWS. Minimum weld size shall be $\frac{3}{6}$ unless noted otherwise.
- 13. Welding of reinforcing bars to other bars or structural steel: E90-XX electrode.
- 14. Cuts, holes, coping, etc. required for other trades or field conditions shall be shown on the shop drawings and made in the shop. Cutting or
- burning of main structural members in the field will not be permitted.

 15. Submit shop drawings for fabrication and erection of structural steel. Clearly indicate coordinated dimensions of mechanical unit and roof penetration sizes. Shop and Erection drawings must show all shop/floor and field welds. Initial shop drawing submittal shall include proposed connection details and job standards. Provide signed and sealed calculations for all non—standard connection details showing design capacities.
- 16. Steel members shown on plan shall be equally spaced unless noted otherwise.
- 17. The General Contractor and Steel Erector shall notify the Structural Engineer of any fabrication or erection errors or deviations and receive written approval before any field corrections are made.
- 18. Alternate connection details may be used if such details are submitted to the engineer for review and approval. However, the engineer shall be the sole judge of acceptance and the Contractor's bid shall anticipate the use of those details shown on the drawings. The Contractor is responsible for the design of such alternate details which he proposes.
- 19. Beams and girders shall have beam web holes as indicated on the structural drawings. All holes shall be centered at mid—depth of the beam unless otherwise noted. All rectangular web holes shall have a minimum corner radius of \(\frac{5}{8} \) or twice the thickness of the beam web, whichever is greater. All web openings shall be machine oxygen cut. Manual cutting or burning is not permitted. Coordinate location and size of hole with mechanical contractor prior to review by the structural engineer.

•					
	2	1/10/23	ISSUED TO PLANNING		
	1	12/10/23	ISSUED FOR REVIEW		
	No.	Date	Comments		
Ī	REVISIONS				

JMF Architect, PLLC 2287 Mark Road Yorktown, NY 10598 914-733-2214 Tel. 914-962-4163 Fax jimflandreau@yahoo.com

IT IS A VIOLATION OF THE NEW YORK STATE EDUCATION LAW FOR ANY PERSON, UNLESS ACTING UNDER THE DIRECTION OF A LICENSED PROFESSIONAL ENGINEER, TO ALTER ANY ITEM ON THIS DRAWING AND/OR RELATED SPECIFICATION. ALL ALTERATIONS MUST BE MADE IN COMPLIANCE WITH THE NEW YORK STATE EDUCATION LAW. THE PROFESSIONAL ENGINEER WHOSE SEAL APPEARS HEREON ASSUMES NO RESPONSIBILITY FOR ANY SUCH ALTERATION OR RE—USE WITHOUT HIS CONSENT.

200

Project
CHANGE OF USE - FIRST FLOCINTERIOR ALTERATIONS
Drawing Title
GENERAL NOTES

Owner's Information
PROSPERO
134 MARBLE AVE
PLEASANTVILLE, NY

Original Date:
11/6/23

Project No:
23-50

A-5

5 of 5 Sheets

PUBLIC NOTICE

All public meetings will be held via in person and via teleconference. To view & attend the meeting noted below via teleconference and address any application with the PC, please visit the Village website (www.pleasantville-ny.gov) the evening of the meeting and follow the Zoom virtual meeting link provided for this specific meeting date. Don't hesitate to contact this office for assistance 914-769-1926.

PLEASE TAKE NOTICE that the Planning Commission of the Village of Pleasantville, New York, on Wednesday, April 9, 2025, at 8:00 P.M., at 80 Wheeler Avenue and via teleconference, will be conducting a Public Hearing with regards to an amended site plan and special use permit application by Melissa Prospero on behalf of Floorcraft (warehouse & retail use), located within the lower level of 134 Marble Avenue, Pleasantville, New York. The property is known as Section 106.10, Block 2, Lot(s) 41 & 42 on the Village Tax Maps. A copy of the aforementioned submission is on file in the office of the Building Inspector and may be examined by any interested persons.

By Order of the Planning Commission Of the Village of Pleasantville Russell Klein, Chairman Pleasantville Planning Commission



APPLICATIONS INVOLVING PLANNING & ARB



325 Manville Road

<u>325 Manville Road - Manville and Grove LLC</u> - Proposed conversion of existing professional office building into a new multiple dwelling consisting of a maximum six (6) residential apartment units - *App back from ZBA - cont review & set public hearing*

ATTACHMENTS:

Description	Type	Upload Date
ARB presentation	Backup Material	4/7/2025
Proposed Site Plan dated 4.8.25	Backup Material	4/4/2025
Proposed Front & Rear Elevations & Sustainability Factors dated 4.8.25	Backup Material	4/4/2025
Proposed Side Elevations dated 4.8.25	Backup Material	4/4/2025
Proposed 1st Floor Plan dated 4.8.25	Backup Material	4/4/2025
Proposed 2nd Floor Plan dated 4.8.25	Backup Material	4/4/2025
Prior Architectural rendering dated 2.12.25	Backup Material	4/4/2025
County comments 3.25.25	Backup Material	4/4/2025
Consultant memo dated 4.9.25	Backup Material	4/9/2025









SUSTAINABILITY FACTORS

TRESPA PANELS

Carbon Capture: Using up to 70% wood fibres, they capture and lock in CO2 absorbed by trees during their growth. When used in ventilated facades, these panels improve energy efficiency by cutting emissions from heating and cooling, helping reduce your project s overall carbon footprint.

Ecofriendly Material: 85% of the materials used to make the panel come from renewable, plant based sources rather than fossil-fuel based materials like plastics.

Durability & Waste Reduction: The combination of wood fibers and Trespa's high-pressure laminate process creates long lasting panels, minimizing material waste overtime.

Green Company: since 2020, Trespa powers all operations with 100% green electricity

HEAT PUMPS

Energy Efficiency: heat pumps produce 3-4 times more energy than they consume. This reduces the amount of energy needed to heat or cool a space, leading to lower energy consumption

Lower Carbon Emissions: only use electricity and do not burn fossil fuels. Produce fewer greenhouse gas emissions compared to traditional heating systems

Versatility: provides both heating and cooling, replacing the need for a separate system for each

SPRAY FOAM INSULATION


Energy Efficiency: creates an airtight seal that prevents air leaks, which help maintain consistent indoor temperatures and lead to a lower energy consumption.


ADAPTIVE REUSE OF EXISTING BUILDING

NEW ENERGY EFFICIENT WINDOWS



- NEW TRESPA RAINSCREEN PANELS
- NEW ALUMINUM WINDOWS
- BLACK GRANITE
- EXISTING BRICK
- METAL ROOF EDGE CLADDING

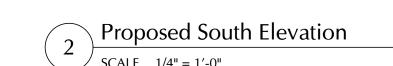

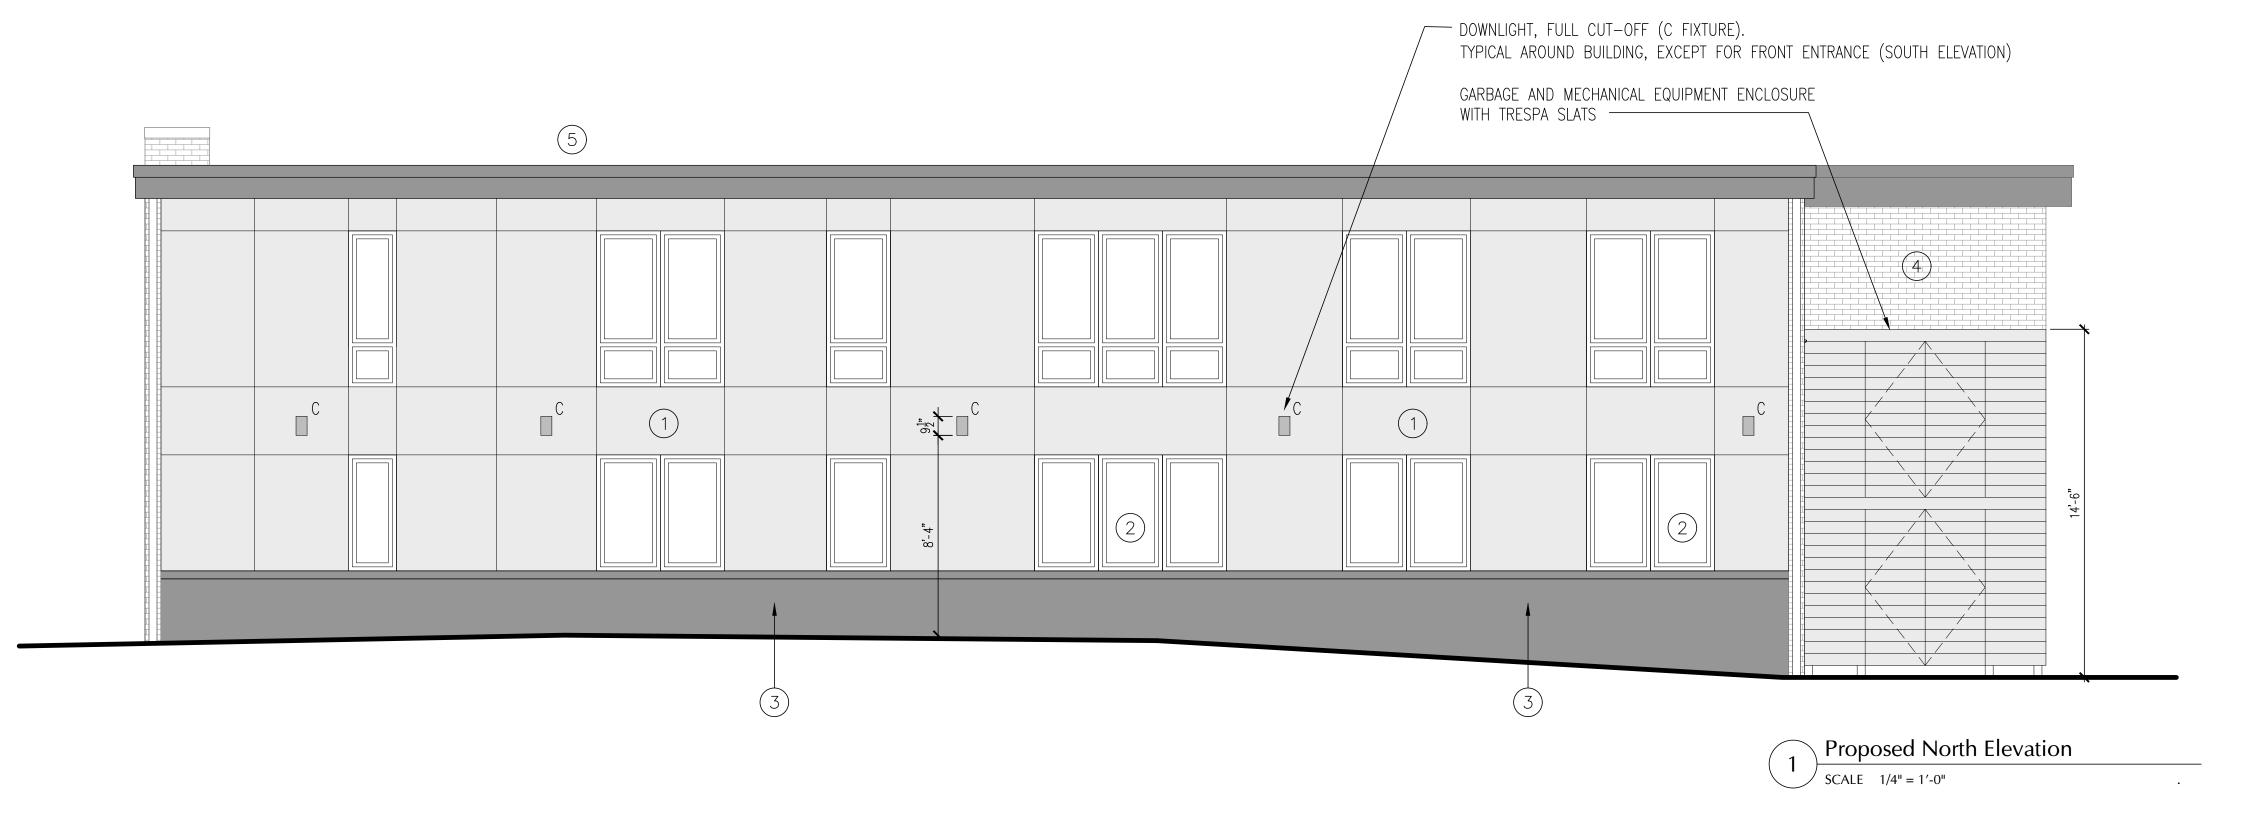

Planning Board Submission

325

MANVILLE

ROAD

ALTERATIONS

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- 04.08.25 Planning Brd. Submission - 03.27.25 Zoning Brd. Submission - O2.12.25 Planning Brd. Submission Rev. Date Description


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Proposed Elevations & Sustainability Factors


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Print Date: 04-08-25

Sheet No.: A20



- NEW ALUMINUM WINDOWS
- EXISTING BRICK
- NEW CAST STONE SILLS
- METAL ROOF EDGE CLADDING

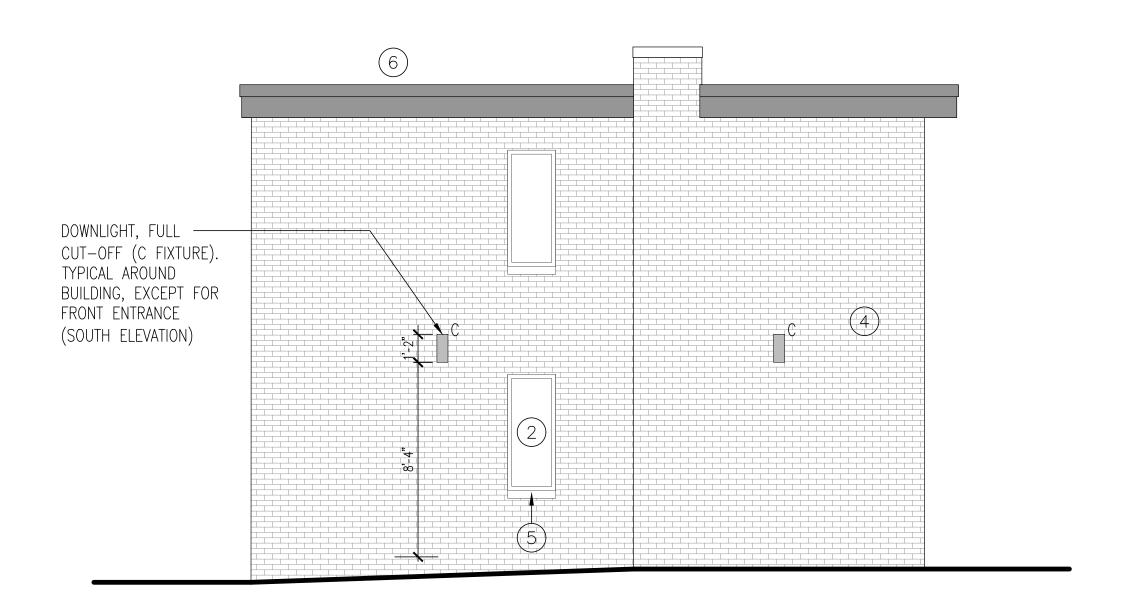

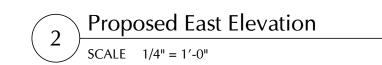6 DOWNLIGHT, FULL

CUT-OFF (C FIXTURE).

TYPICAL AROUND

BUILDING, EXCEPT FOR FRONT ENTRANCE (SOUTH ELEVATION) GARBAGE AND MECHANICAL EQUIPMENT ENCLOSURE WITH TRESPA SLATS

> \ Proposed West Elevation SCALE 1/4" = 1'-0"

MANVILLE ROAD **ALTERATIONS**

Manville and Grove, LLC 325 Manville Road Pleasantville, NY 10570

Architect

Gallin Beeler Design Studio, PLLC 23 Washington Avenue Pleasantville NY, 10570

Planning Board Submission

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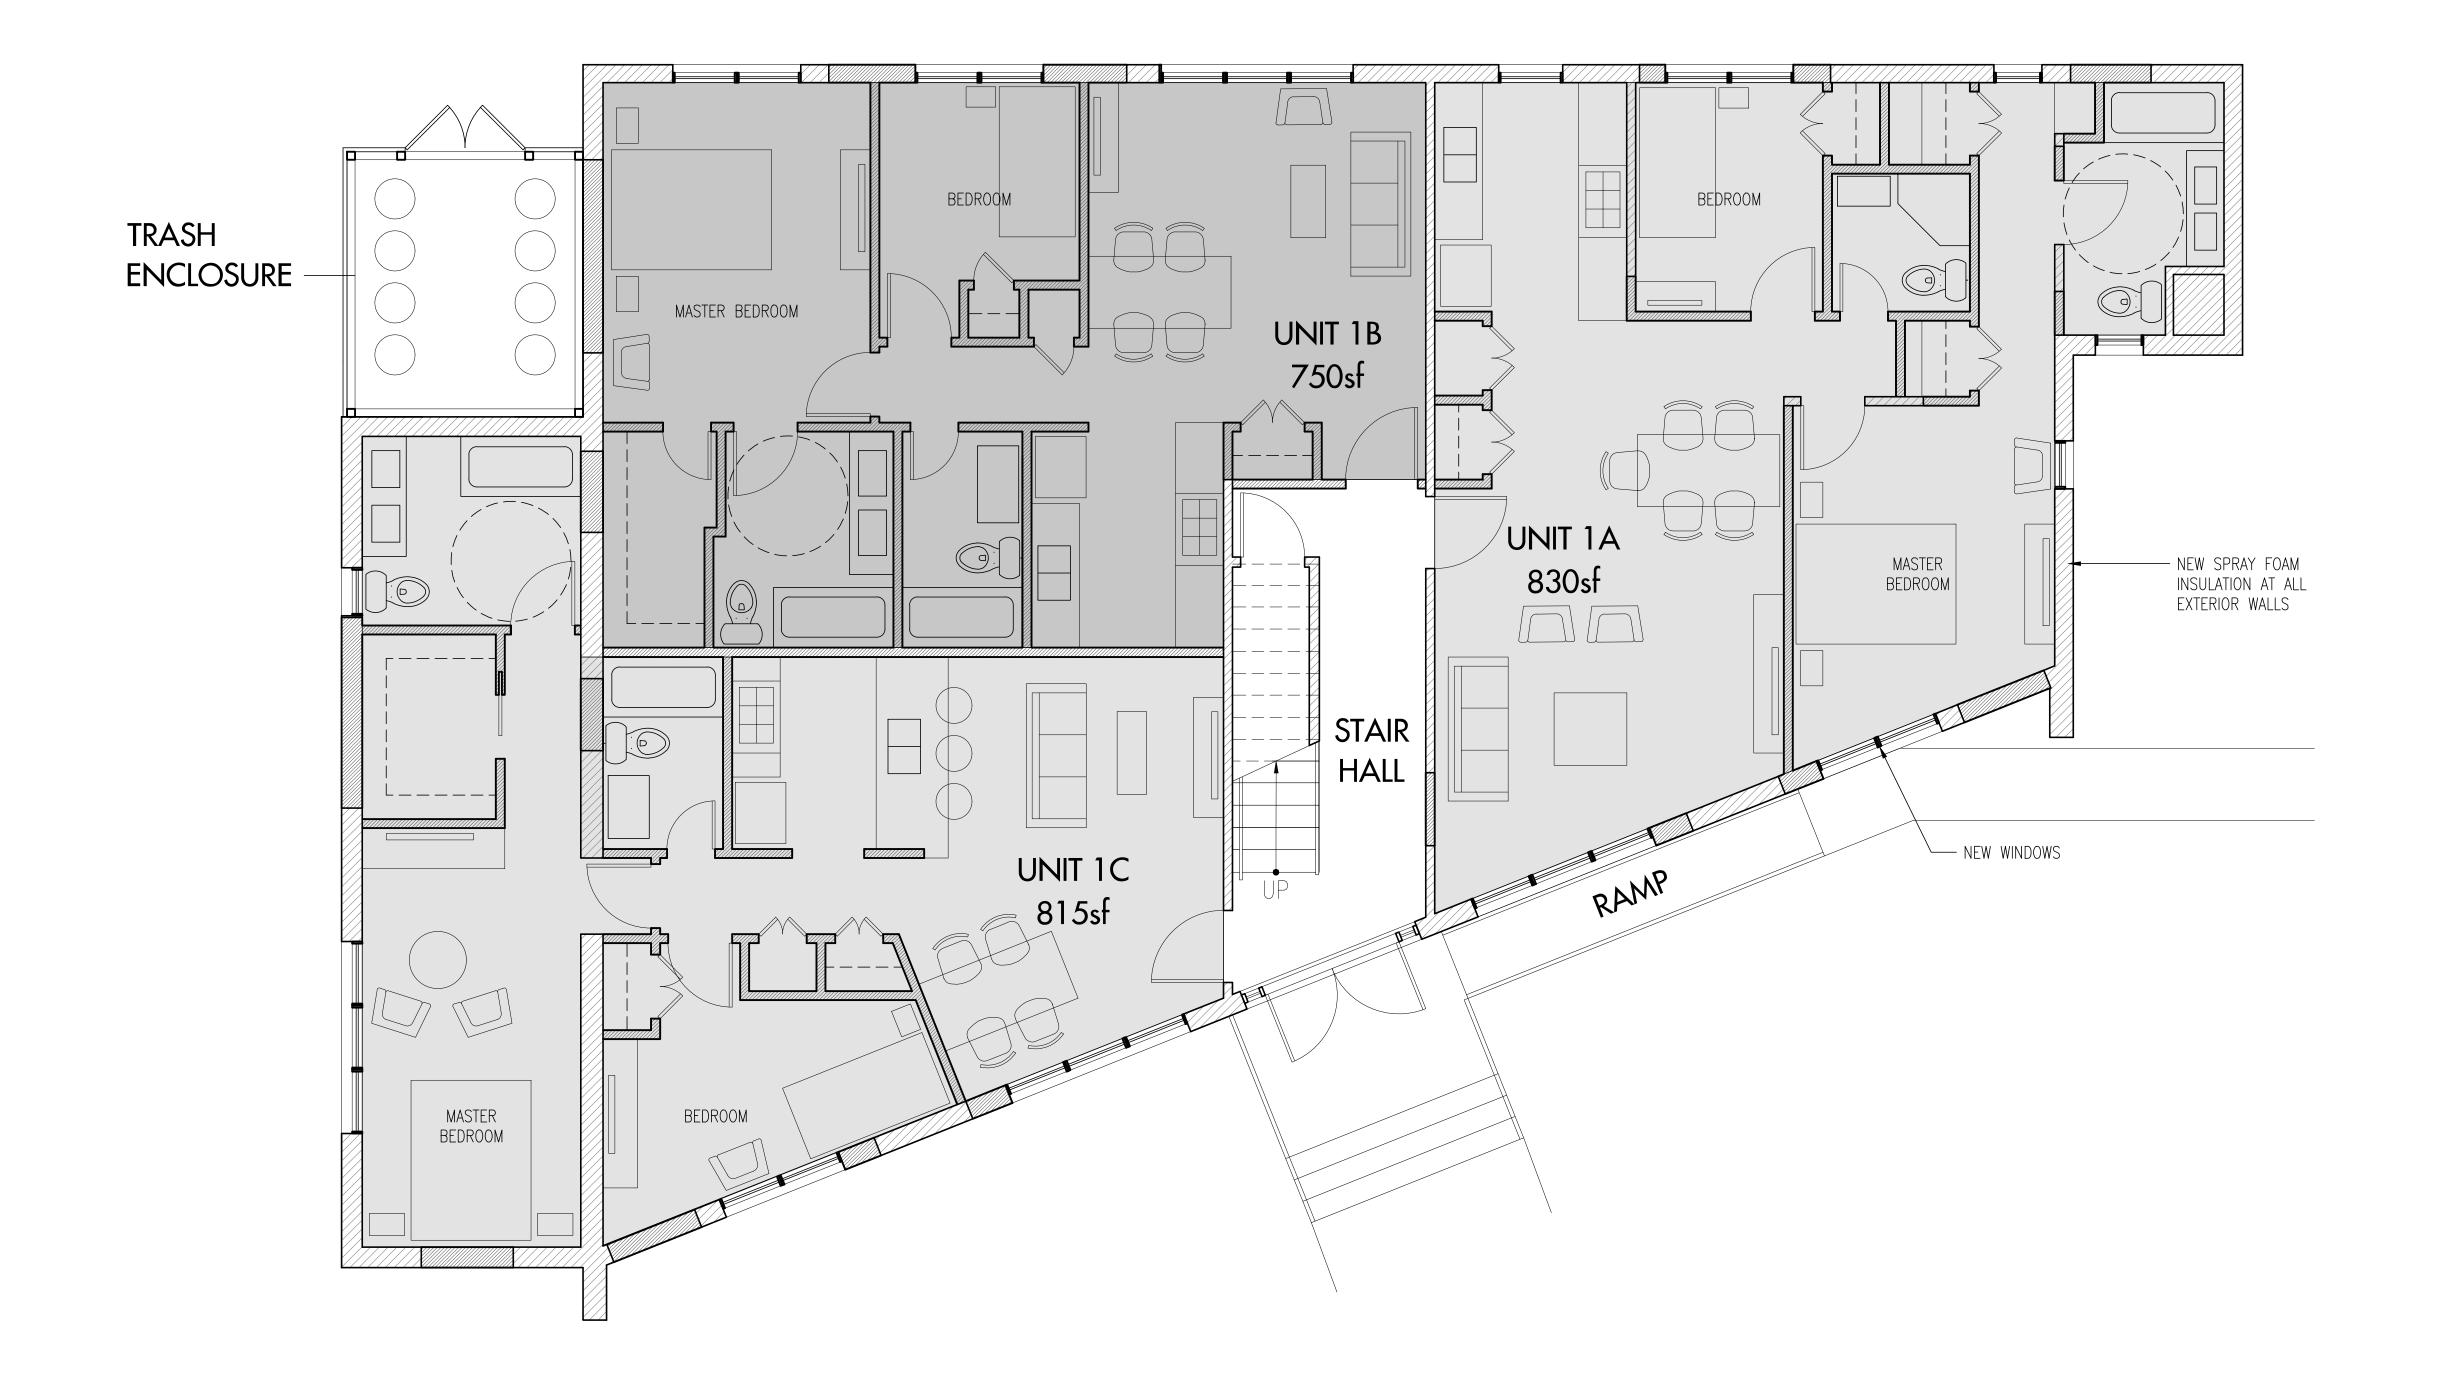
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 O3.27.25 Zoning Brd. Submission
 O2.12.25 Planning Brd. Submission
 Rev. Date Description

Sheet Title:

Proposed Elevations

Project #: 2501 Sheet No.: Drawn: RB Checked: RB

A22 Print Date: 04-08-25



Proposed 1st Floor Plan SCALE 1/4" = 1'-0"

(3) 2 BEDROOM UNITS

325 MANVILLE ROAD

ALTERATIONS

Manville and Grove, LLC 325 Manville Road Pleasantville, NY 10570


Architect

Gallin Beeler Design Studio, PLLC 23 Washington Avenue Pleasantville NY, 10570



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 Rev. Date Description


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Proposed 1st Floor Plan

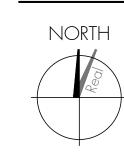Project #: 2501 Drawn: RB Checked: RB

Print Date: 04-08-25

Sheet No.: A10

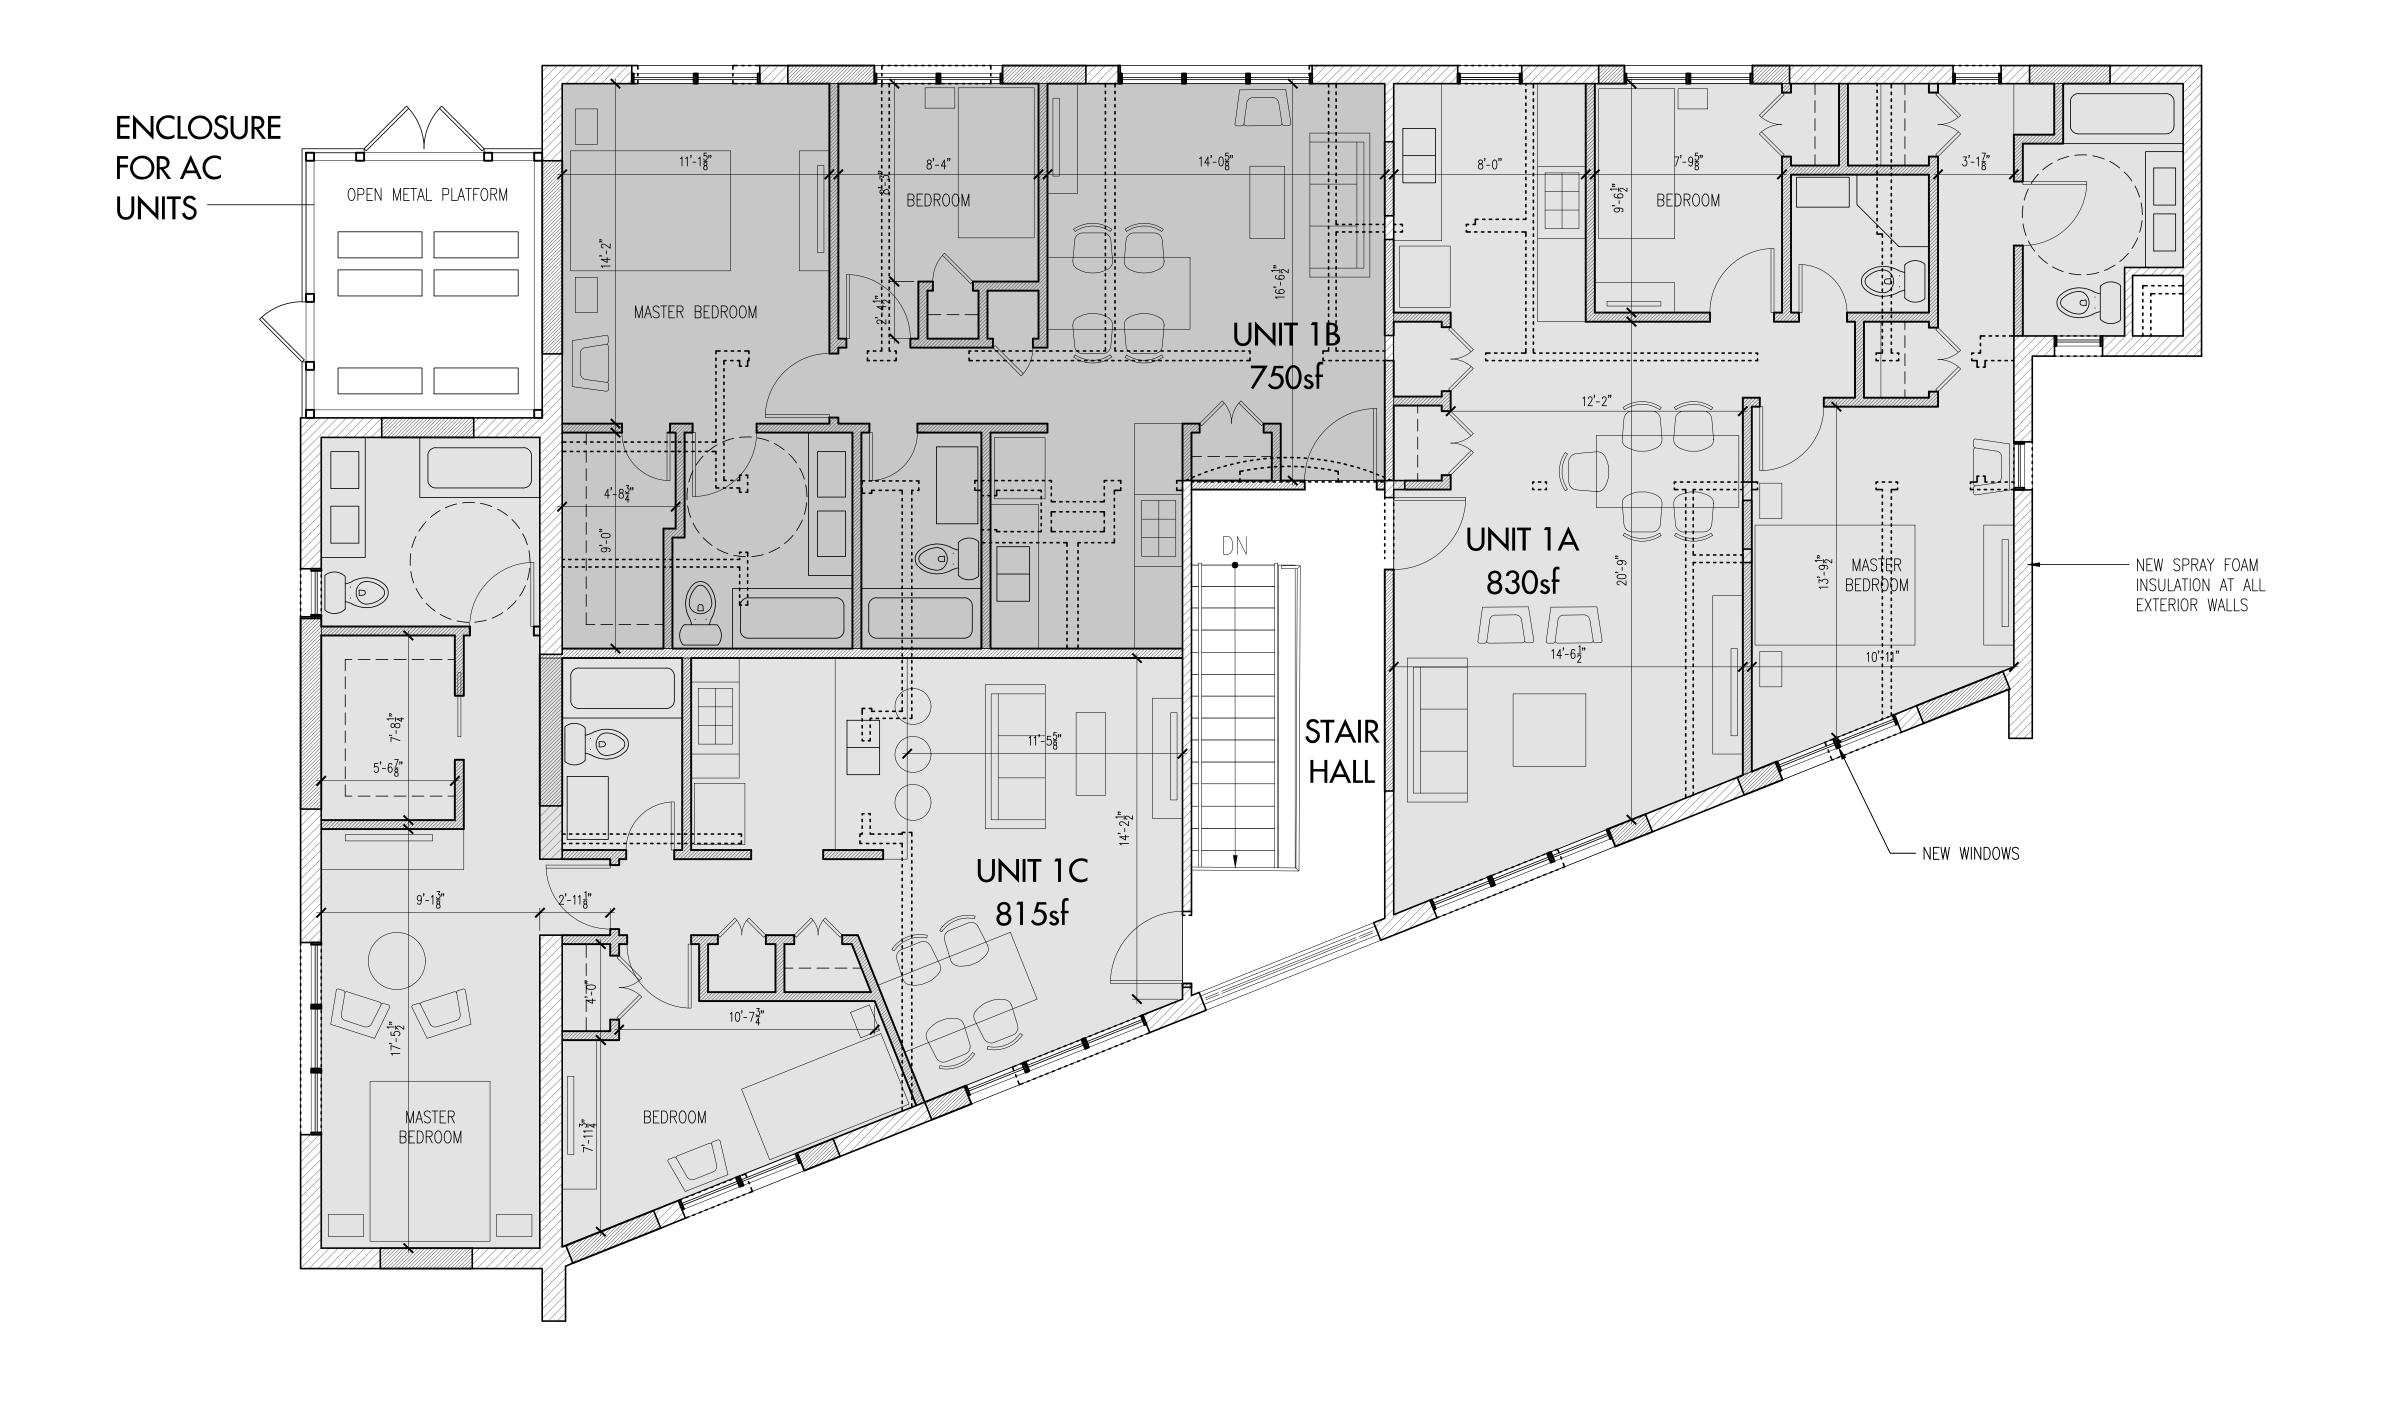

Proposed 2nd Floor Plan SCALE 1/4" = 1'-0"

(3) 2 BEDROOM UNITS

325 MANVILLE ROAD

ALTERATIONS

Manville and Grove, LLC 325 Manville Road Pleasantville, NY 10570


Architect

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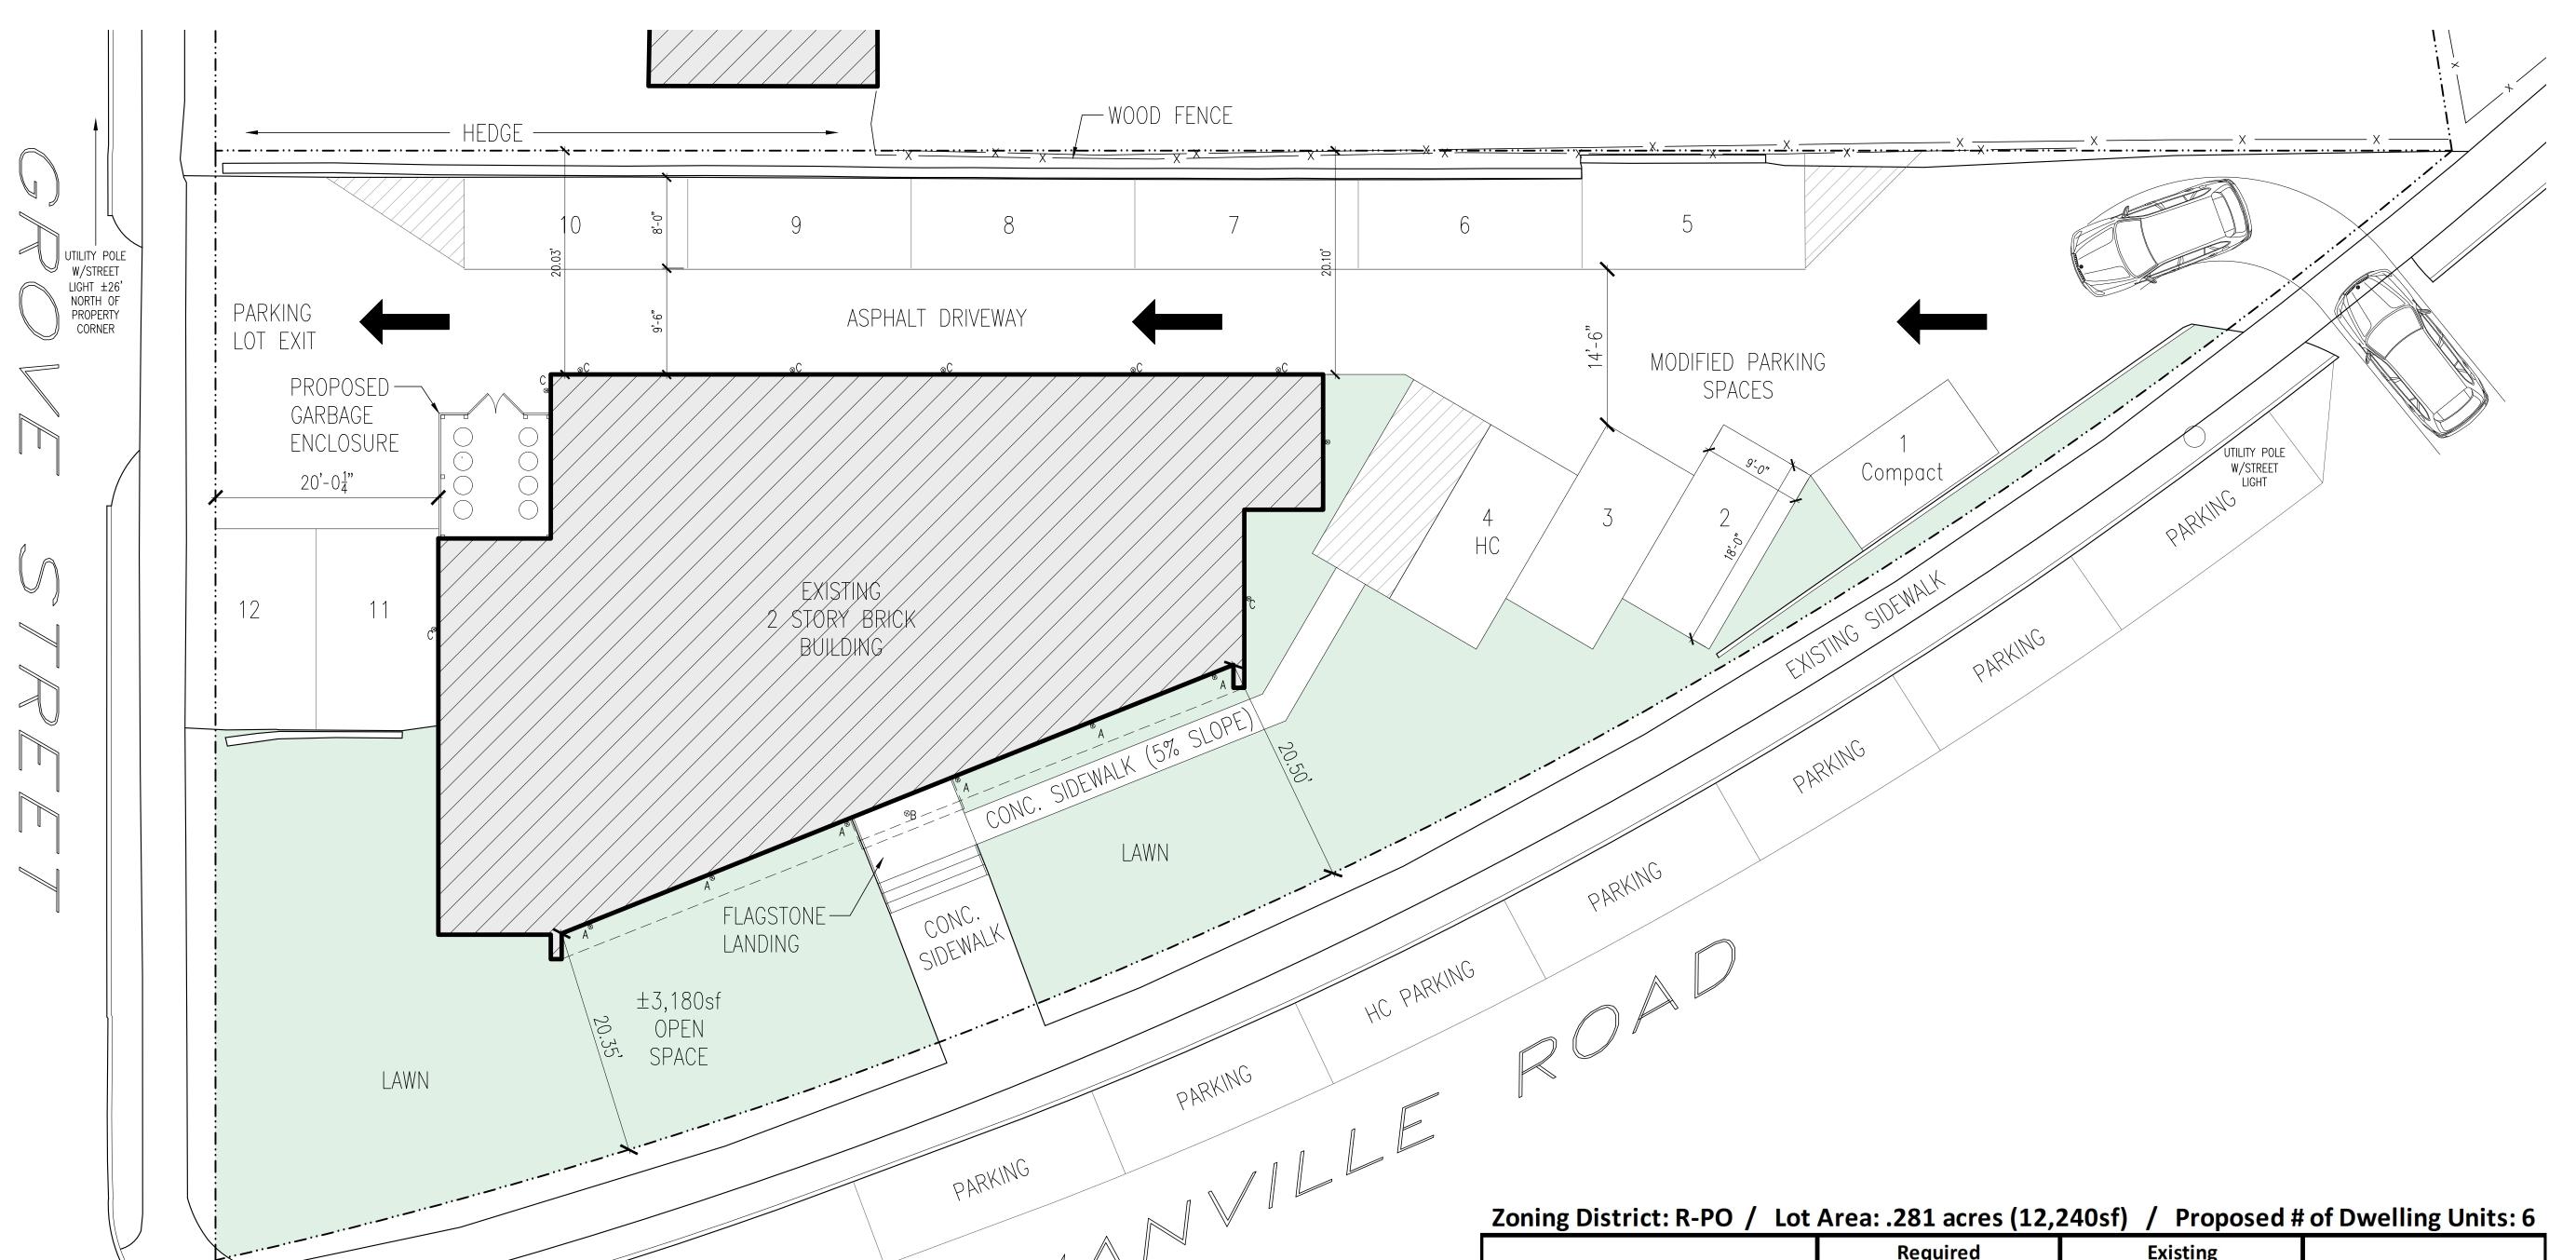
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Proposed 2nd Floor Plan

Project #: 2501 Drawn: RB Checked: RB

Print Date: 04-08-25

Sheet No.: A12

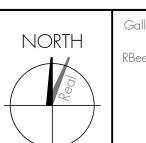

12,240.5sf

3,179sf

9,061.5sf (74.0%)

UTILITY POLE W/STREET LIGHT

Existing Developed Area

Pervious Area - i.e. grass

Existing Developed Area

Site Area

Proposed Site Plan

12,240.5sf

3,119.5sf

9,121sf (74.52%)

Proposed Developed Area

Pervious Area - i.e. grass

Proposed Developed Area

Site Area

SCALE 1/8" = 1'-0"

	Required / Allowed	Existing / Proposed	Compliant
Minimum Lot Area	20,000sf	12,240.5sf	Variance Required
Minimum Lot Frontage	75'	225'	Yes
Minimum Lot Width	75'	approx. 200'	Yes
Minimum Lot Depth	100'	varies from 99' to 0'	*PENC
Minimum Front Yard	30'	20.35'	*PENC
Minimum Side Yard	30'	20.01'	*PENC
Minimum Rear Yard	30'	20.03'	*PENC
Minimum Gross Area per Dwelling Unit	800sf	930sf	Yes
Maximum Height	2.5 stories / 30'	2 stories / 22'	Yes
Maximum Building Coverage	30%	22.80%	Yes
Maximum Developed Coverage	60%	74.5% existing 74% proposed	74% *PENC reduced
Maximum FAR	0.4	0.46	*PENC
Maximum Open Space	400sf per dwelling unit	3,200sf	Yes
Parking	2 spaces per dwelling unit	12 spaces	Yes

*PENC = Pre-Existing Non-Conformance

MANVILLE ROAD

ALTERATIONS

Manville and Grove, LLC


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Planning Submission

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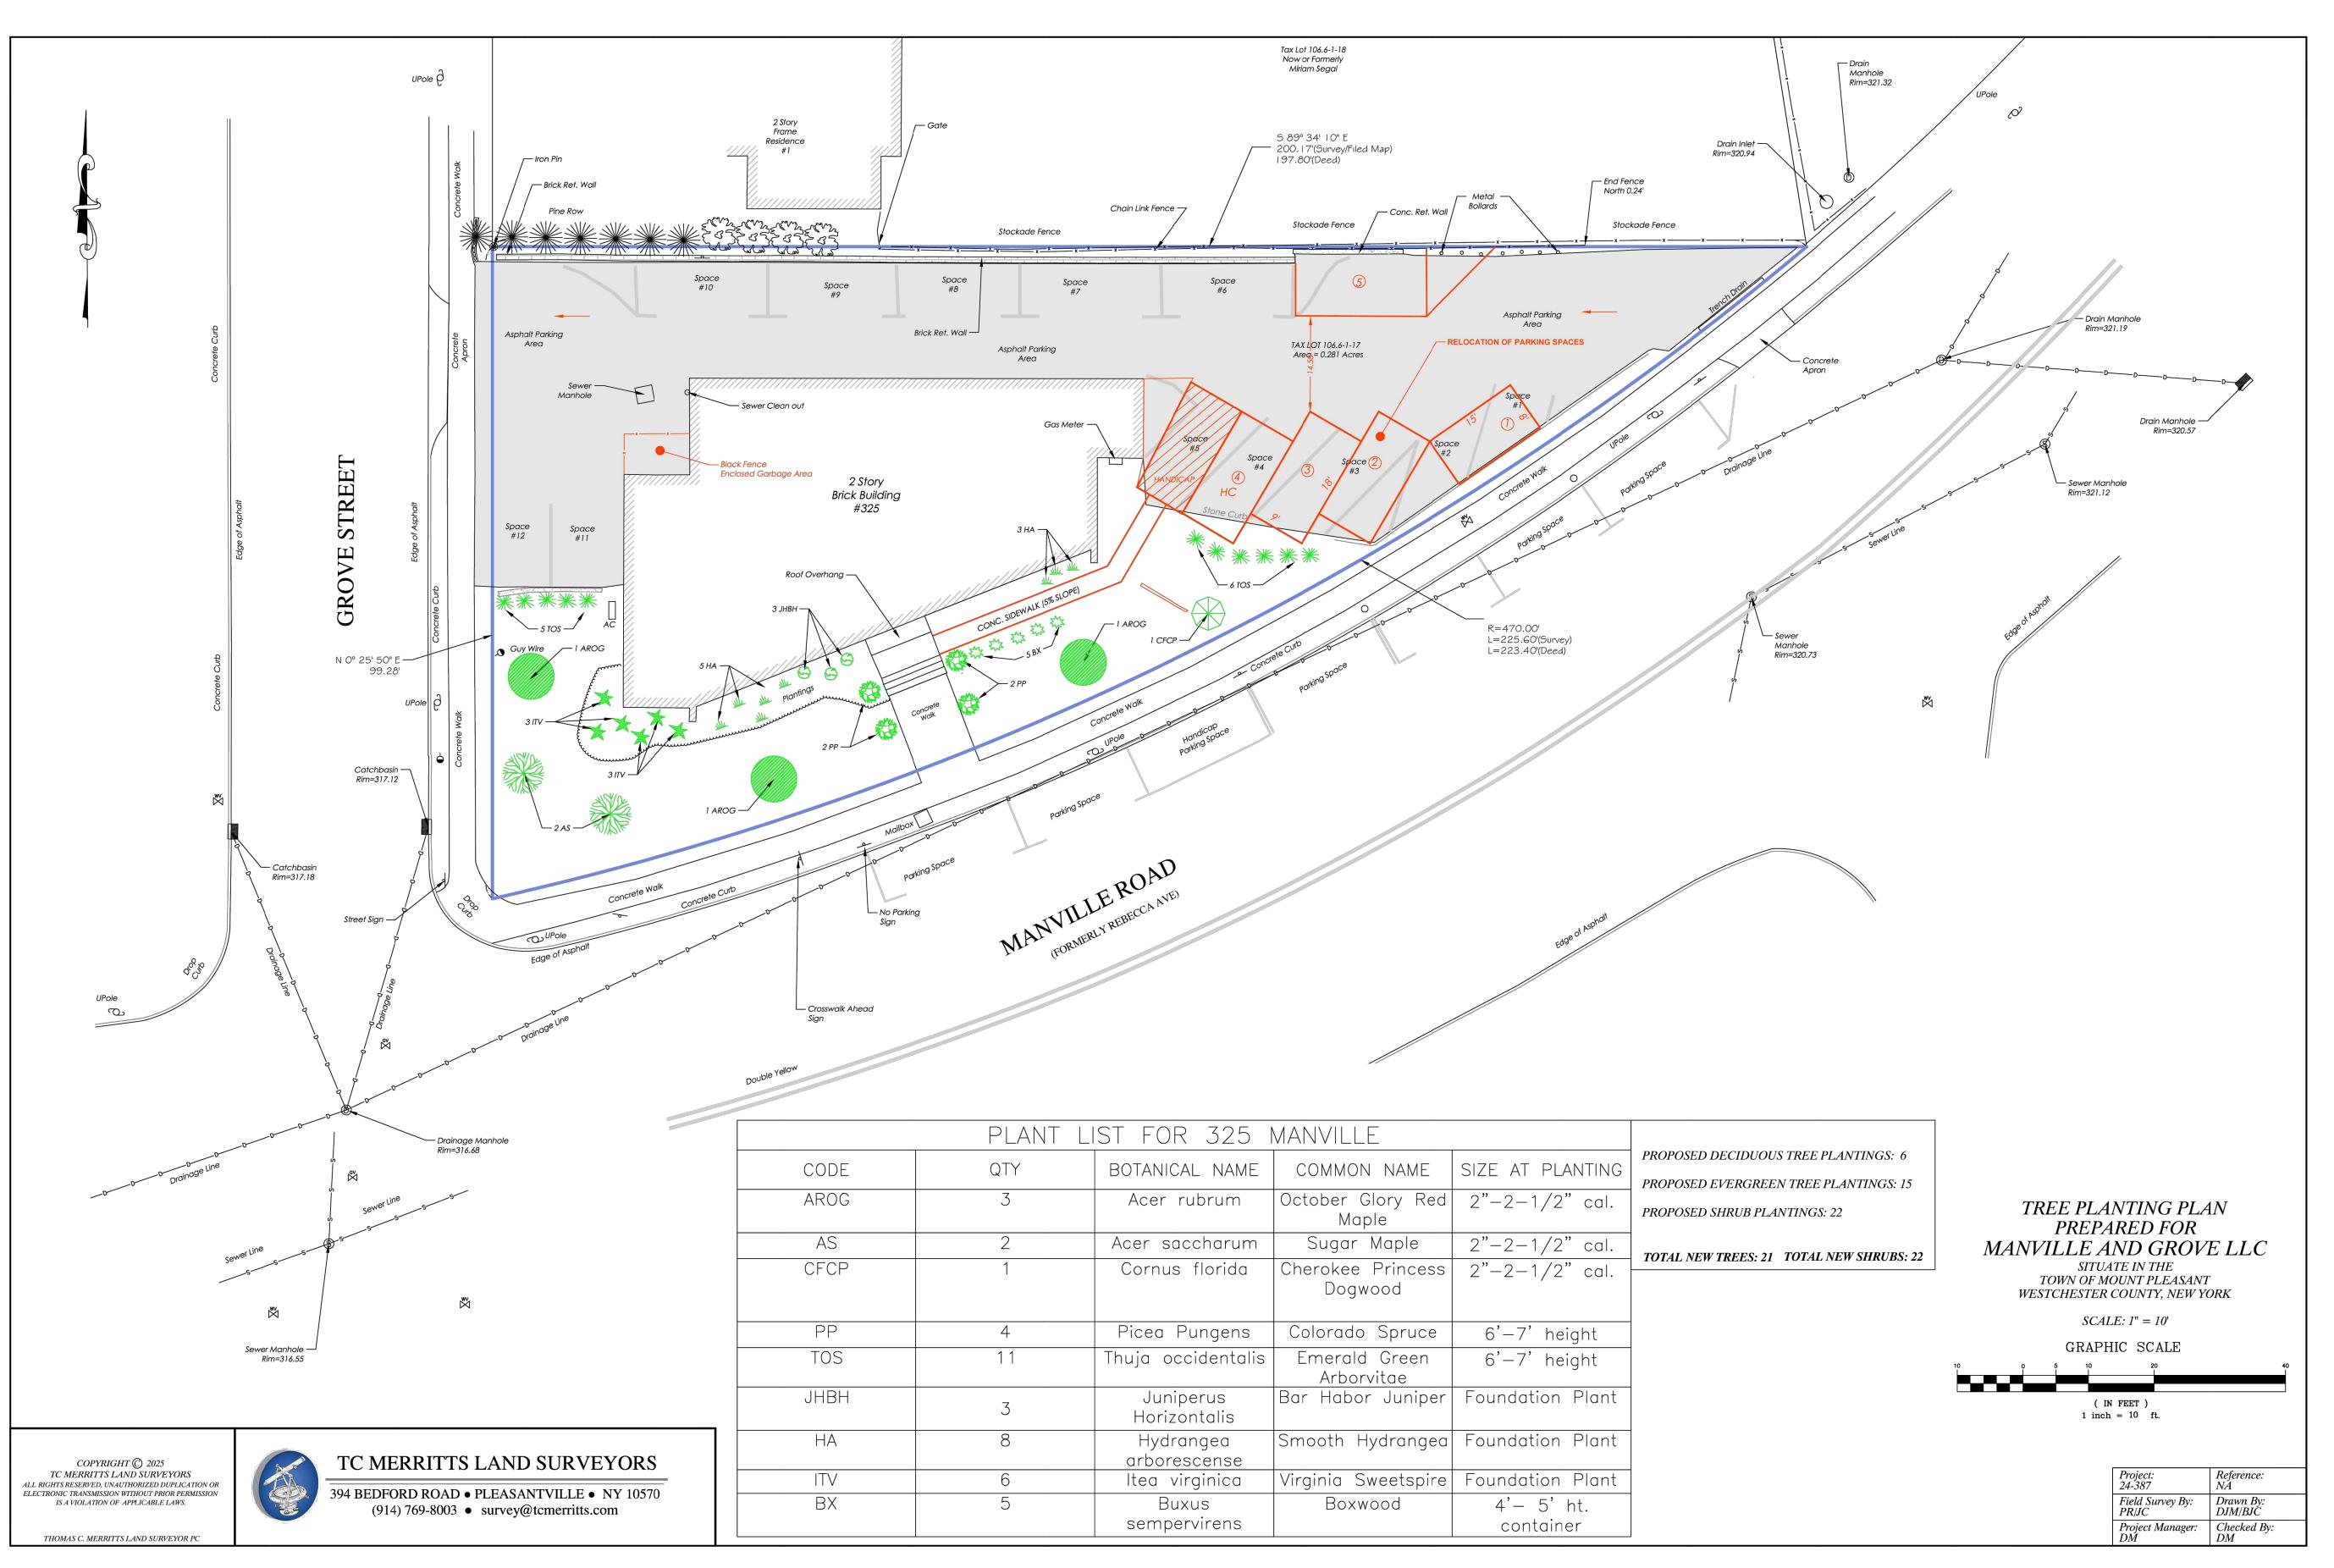
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	-	04.08.25	Planning Brd. Submission
	-	03.27.25	Zoning Brd. Submission
	-	02.12.25	Planning Brd. Submission
	Rev.	Date	Description

Sheet Title:

Proposed Site Plan

Project #: 2501 Sheet No.: Drawn: RB A04 Checked: RB

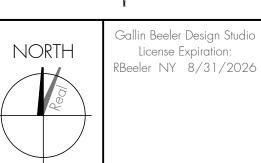Print Date: 04-08-25



MANVILLE ROAD

ALTERATIONS

Manville and Grove, LLC 325 Manville Road

Pleasantville, NY 10570


Architect

Gallin Beeler Design Studio, PLLC

23 Washington Avenue Pleasantville NY, 10570

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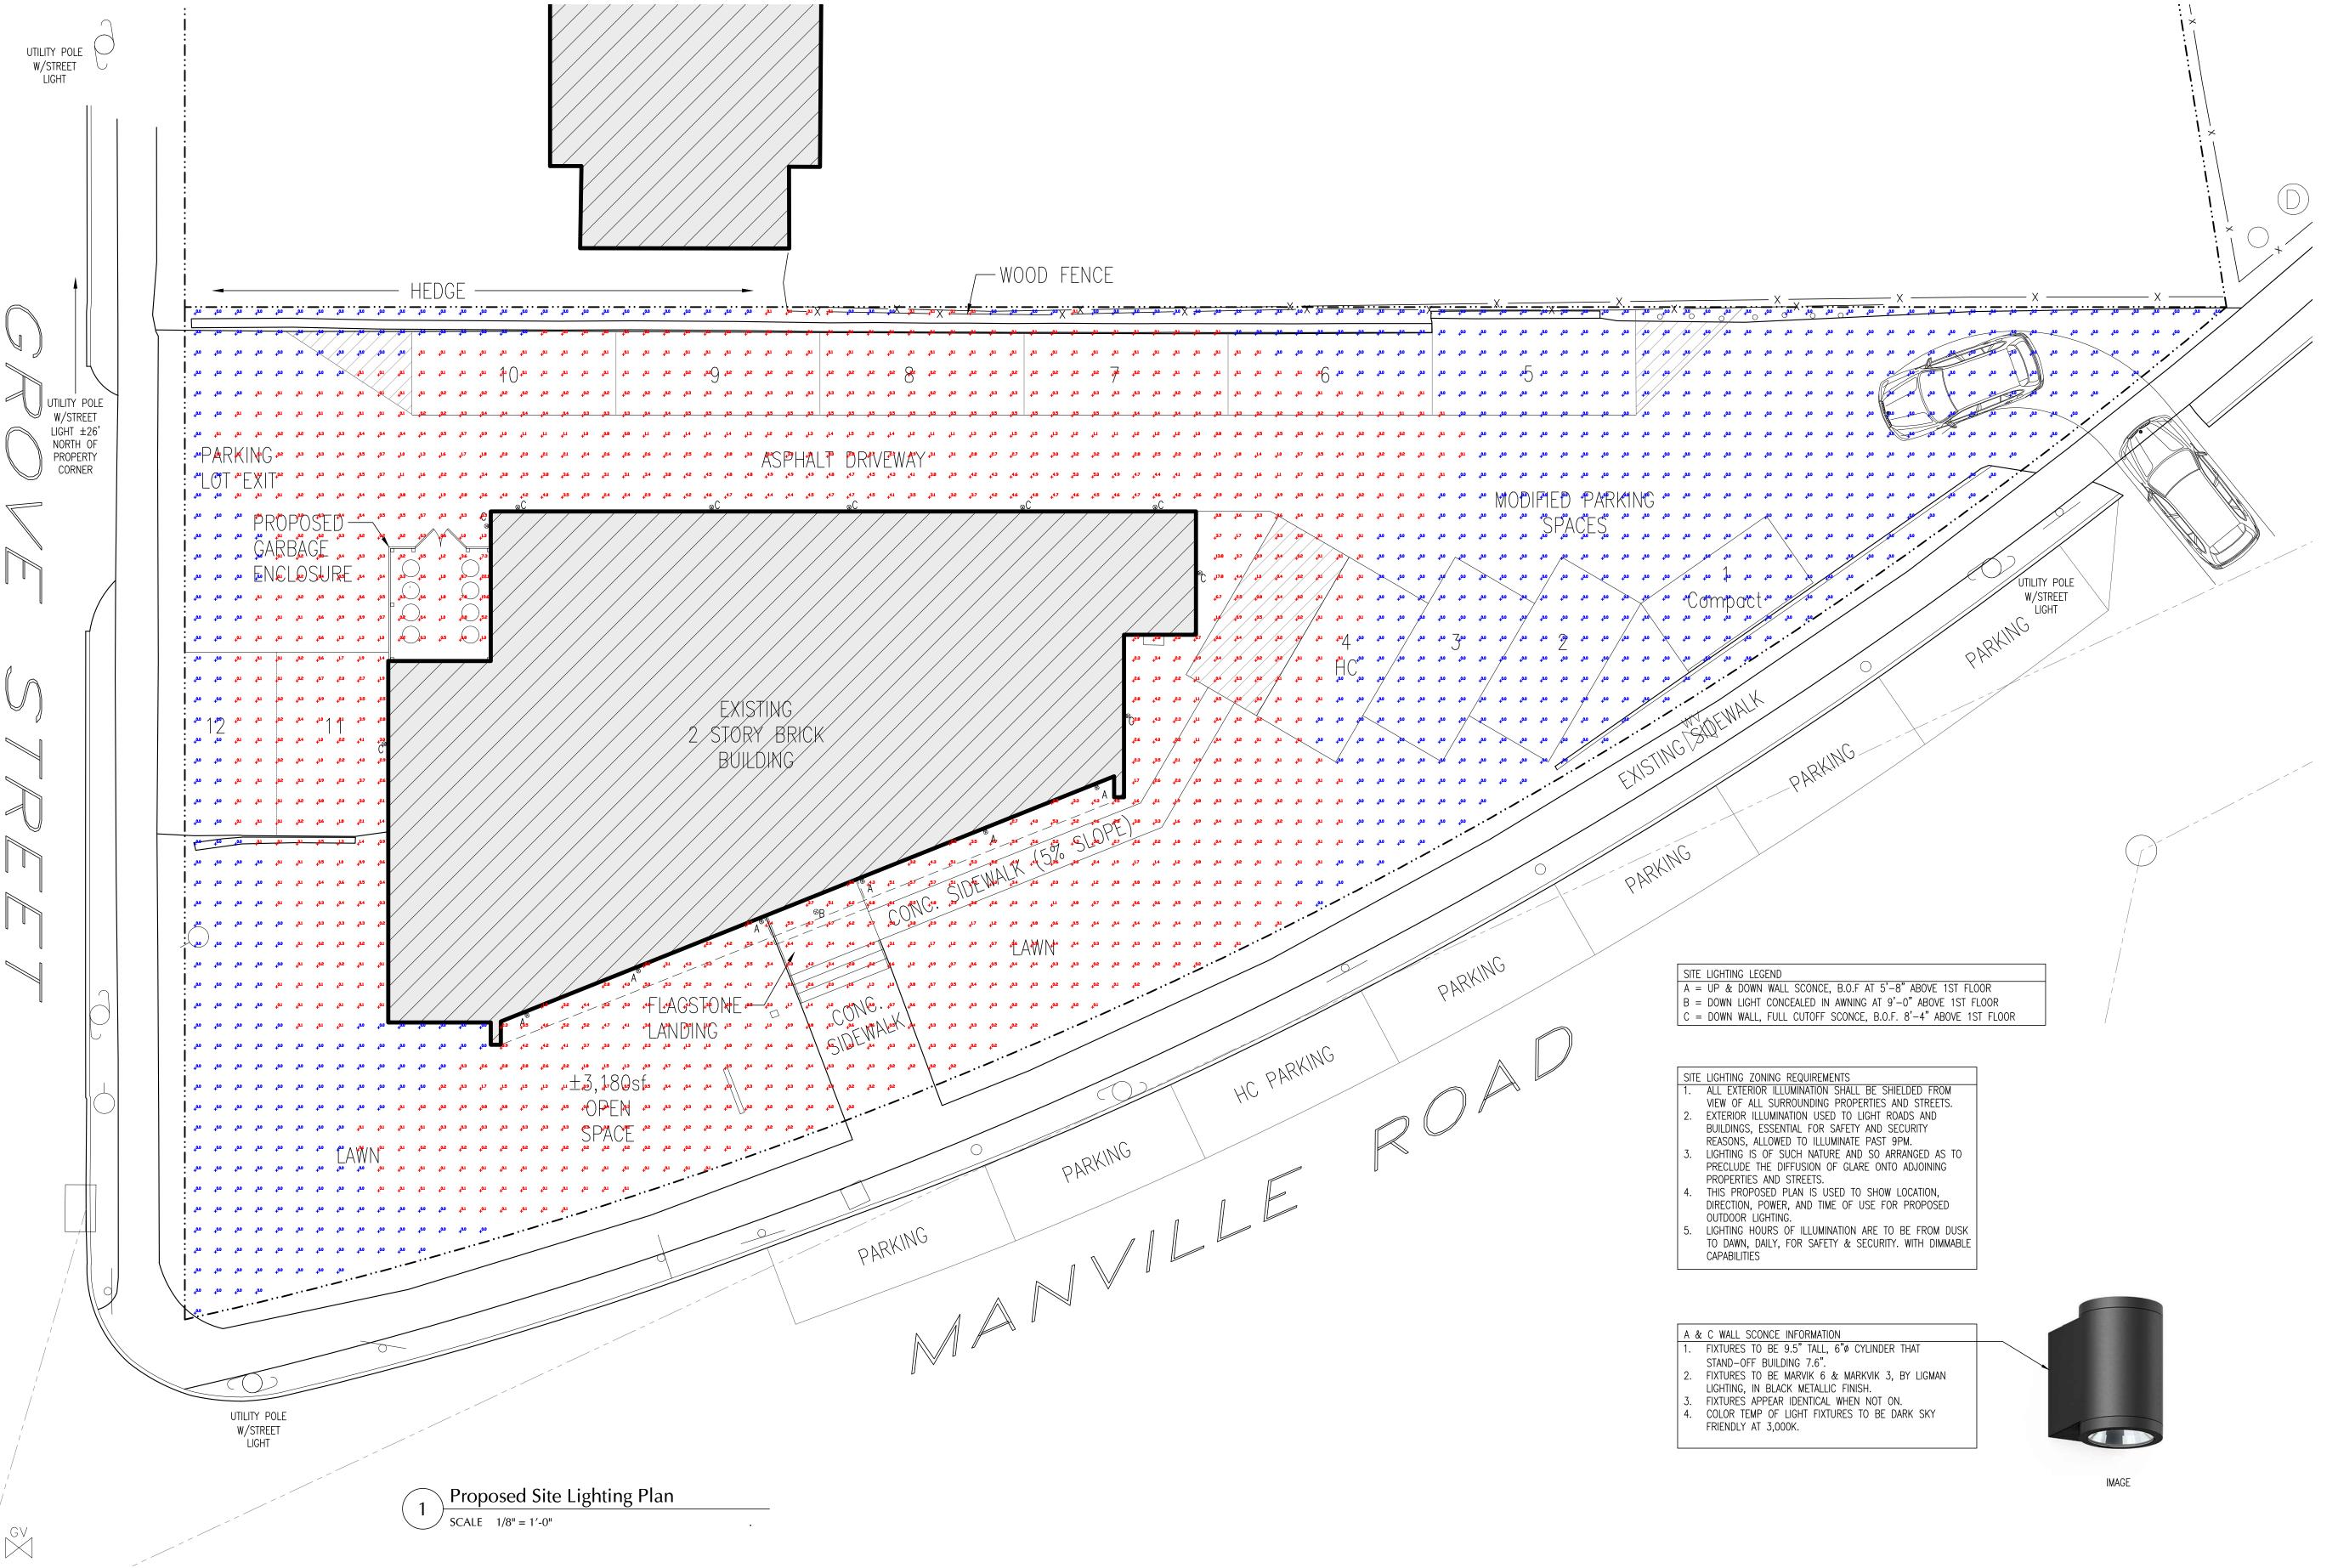
- 03.27.25 Zoning Brd. Submission
- 02.12.25 Planning Brd. Submission
Rev. Date Description

Sheet Title:

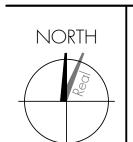Landscape Plan

Print Date: 03-27-25

Project #: 2501 Sheet No.: Drawn: RB A05 Checked: RB



MANVILLE ROAD

ALTERATIONS

Manville and Grove, LLC

325 Manville Road Pleasantville, NY 10570

Gallin Beeler Design Studio, PLLC 23 Washington Avenue Pleasantville NY, 10570

Planning Submission

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O4.08.25 Planning Brd. Submission
 O3.27.25 Zoning Brd. Submission
 O2.12.25 Planning Brd. Submission
 Rev. Date Description

Sheet Title:

Proposed Site Lighting Plan

Project #: 2501 Drawn: RB Checked: RB

Print Date: 04-08-25

Sheet No.: A04A



Hawthorne

Outdoor Ceiling Mount 3000K

		•			
Model & Size	Color Temp	Finish	LED Watts	LED Lumens	Delivered Lumens
FM-W33113 13"	3000K	BK Black	20W	941	684

Example: FM-W33113-BK

For custom requests please contact customs@waclighting.com

DESCRIPTION

Clean lines for a stunning look. Modern minimalism.

FEATURES

- Hammered glass panels on five sides
- Stainless steel textured reflector
- Driver concealed within the canopy
- 5 Year warranty

SPECIFICATIONS

Color Temp: 3000K

Input: 120-277V,50/60Hz

CRI

Dimming: ELV: 100-10%, TRIAC: 100-10%

Rated Life: 50,000 Hours

Mounting: Can be mounted on ceiling or wall in all orientations

Standards: ETL, cETL, IP65, Wet Location Listed

Construction Aluminum body, hammered glass diffuser

REPLACEMENT PARTS

RPL-GLA-33113-SI - Side Glass



FINISHES:

Fixture Type:


Project:

Location:

Catalog Number:



LINE DRAWING:

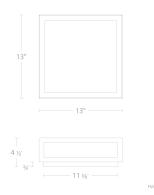

insight lighting

SCOPE LARGE SCONCE

CYLINDER UP OR DOWN, UP/DOWN | WHITE LIGH

PROJECT:

TYPE:

CATALOG #: SSL - - MO -

- WM -

PROFILE

WATTAGE MO (40.0W) IN EITHER DIRECTION

OPTICS 15°, 30°, 55°, ASYMMETRIC

CCT 2700K, 3000K, 3500K, 4000K (82 CRI)

CRI 82+ CRI

PERFORMANCE UP TO 10725 PEAK CANDELA (MO)

VOLTAGE 120V OR 277V

POWER INTEGRATED POWER SUPPLY

DIMMING 0-10V, DMX

DIMENSIONS 12.00" X 5.10", 16.00" X 5.10"

HOUSING EXTRUDED ALUMINUM HOUSING

LENS TEMPERED GLASS

FINISH HIGH DURABILITY POWDER COATING

WARRANTY 5-YEAR LIMITED

OPERATING TEMP -30° C TO 45° C

LUMEN MAINTENANCE 84 000 HOURS

CERTIFICATION ETL AND CETL FOR WET LOCATION










STANDARD FINISHES




OPTICS

NOT ALL AVAILABLE OPTICS SHOWN

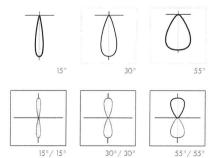

PROFILE

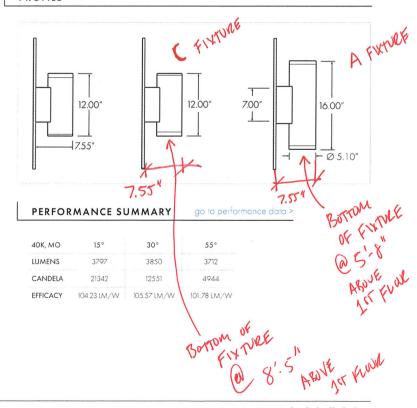

Statistics

Description Symbol Avg Max Min Max/Min Avg/Min

Calc Zone #1 + 0.7 fc 22.1 fc 0.0 fc N/A N/A

Schedule											
Symbol	Label	Image	Quantity	Manufacturer	Catalog Number	Description	Number Lamps	Lumens Per Lamp	Light Loss Factor	Wattage	Plot
	A		1	WAC Lighting	FM-W33113	Surface-mounted Luminaires	1	684	0.9	19.8589	Max: 155cd
	В		6	LIGMAN	MV-30023-T2-W30	Marvik 3 medium down light	2	575	0.9	20	Max: 902cd
	D		6	LIGMAN	MV-30023-M-W30	Marvik 3 medium down light	2	693	0.9	20	Max: 3980cd
	н		7	LIGMAN	MV-30023-T2-W30	Marvik 3 medium down light	2	575	0.9	20	Max: 902cd
	J		2	LIGMAN	MV-30023-M-W30	Marvik 3 medium down light	2	693	0.9	20	Max: 3980cd



Manville Road Apartment Exterior Lighting Ligman Lighting and WAC

Designer

Date 04/04/2025 Scale Not to Scale Drawing No.

Summary

1 of 1

UMV-30023

Marvik 3 Surface Downlight







IK08 • Impact Resistant (Vandal Resistant)

9.4"

Ø.23'

TECHNOLOGY

distributions for optimized spacing and uniformity.

Ligman's micro Variable Optical System provides the ability to interchange, mix & rotate optics to provide specific light

Mounting Detail

20w LED 1627 Lumens

Weight 10.5 lbs

IP65 • Suitable For Wet Locations

7.6"



Construction

Less than 0.1% copper content – Marine Grade 6060 extruded & LM6 Aluminum High Pressure die casting provides excellent mechanical strength , clean detailed product lines and excellent

Pre paint

8 step degrease and phosphate process that includes deoxidizing and etching as well as a zinc and nickel phosphate process before product painting.

Memory Retentive -Silicon Gasket

Provided with special injection molded "fit for purpose" long life high temperature memory retentive silicon gaskets. Maintains the gaskets exact profile and seal over years of use and compression.

Thermal management

I M6 Aluminum is used for its excellent mechanical strength and thermal dissipation properties in low and high ambient temperatures. The superior thermal heat sink design by Ligman used in conjunction with the driver, controls thermals below critical temperature range to ensure maximum luminous flux output, as well as providing long LED service life and ensuring less than 10% lumen depreciation at 50,000 hours.

Surge Suppression

Standard 10kv surge suppressor provided with all fixtures.

BUG Rating

Finishing

All Ligman products go through an extensive finishing process that includes fettling to improve paint adherence.

UV Stabilized 4.9Mil thick powder coat paint and baked at 200 Deg C. This process ensures that Ligman products can withstand harsh environments. Rated for use in natatoriums.

Inspired by Nature Finishes

The Inspired by nature Finishing is a unique system of decorative powder coating. Our metal decoration process can easily transform the appearance of metal or aluminum product into a wood grain finish.

This patented technology enables the simulation of wood grain, and even marble or granite finish through the use of decorative

The wood grain finish is so realistic that it's almost undistinguishable from real wood, even from a close visual inspection. The system of coating permeates the entire thickness of the coat and as a result, the coating cannot be removed by normal rubbing, chipping, or scratching.

<u>The Coating Process</u>
After pre-treatment the prepared parts are powder coated with a specially formulated polyurethane powder. This powder provides protection against wear, abrasion, impact and corrosion and acts as the relief base color for the finalized metal

The component is then wrapped with a sheet of non-porous film with the selected decoration pattern printed on it using special high temperature inks.

This printed film transfer is vacuum-sealed to the surface for a complete thermo print and then transferred into a customized oven. The oven transforms the ink into different forms within the paint layer before it becomes solid. Finally, the film is removed, and a vivid timber look on aluminum remains

Wood grain coating can create beautiful wood-looking products of any sort. There are over 300 combinations of designs currently in use. Wood grains can be made with different colors, designs, etc.

Our powder coatings are certified for indoor and outdoor applications and are backed by a comprehensive warranty. These coatings rise to the highest conceivable standard of performance excellence and design innovation.

- Added Benefits
 Resistance to salt-acid room, accelerated aging Boiling water, lime and condensed water resistant
- Anti-Graffiti, Anti-Slip, Anti-Microbial, Anti-Scratch Super durable (UV resistant)
- · TGIC free (non-toxic)

The variable optic system allows for the designer to create

Provided Hardware is Marine grade 316 Stainless steel.

Anti Seize Screw Holes

Tapped holes are infused with a special anti seize compound designed to prevent seizure of threaded connections, due to electrolysis from heat, corrosive atmospheres and moisture.

Crystal Clear Low Iron Glass Lens

Provided with tempered, impact resistant crystal clear low iron glass ensuring no green glass tinge.

Optics & LED Precise optic design provides exceptional light control and precise distribution of light. LED CRI > 80

Lumen - Maintenance Life

L80 /B10 at 50,000 hours (This means that at least 90% of the LED still achieve 80% of their original flux)

Cylindrical, single or double-sided wall family. Compact and decorative appearance belies powerful outputs and technical optics for perfect task illumina-

A stunning new waterproof & dust proof wall cylinder range, designed with no visible fasteners, a one-piece body and integrated driver housing.

This smart mechanical modern designed luminaire with cylindrical body provides a stylish solution to wall mounted cylinders.

This innovative design houses a variety of COB wattages to suit designer's specific requirements as well as a selction of field interchangeable reflector optics, that include narrow, medium, wide and very wide distributions. This series is available in 3 different diameters, namely 3", 4" & 6" to suit lighting design requirements.


These luminaires are suitable for various facade lighting requirements along with accent lighting, building columns and architectural highlighting etc. The Marvik 1 protrudes 4" from the wall, making this product suitable for ADA applications.

This luminaire range can be provided with a bayonet lock baffle to reduce glare, as well as a frosted lens option. The SCE surface conduit entry box option can be provided as an option for an attractive solution to surface conduit

Ligman can also provide custom made boxes to fit on a round surface like a column, pillar or pole.


To meet International Dark Sky criteria, 3000k or warmer LEDs must be selected and luminaire fix mounted (+/- 15° allowable to permit leveling).

Additional Options (Consult Factory For Pricing)

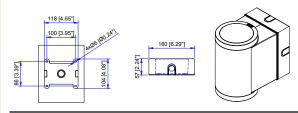

SCBT Surface Conduit Box Trim

NOTE: This trim covers a shallow single gang, surface mount junction box [Provided by contractor] Example: Hubbell: - 5322-0 - 1-Gang Weatherproof Box, Five 1/2" in. Threaded Outlets - or - 5332-0 1-Gang Weatherproof Box, Five 3/4 in. Threaded Outlets

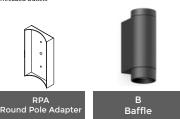



hybrid distributions for precise lighting requirements.

UMV-30023

Marvik 3 Surface Downlight





PROJECT DATE QUANTITY NOTE **TYPE** ORDERING EXAMPLE || UMV - 30023 - 20w - M - W30 - 02 - 120/277v - Options UMV-30023 **LAMP BEAM LED COLOR FINISH COLOR VOLTAGE** 20w LED M - Medium 32° W27 - 2700K 🥮 01 - BLACK RAL 9011 120/277v 1627 Lumens W - Wide 52° W30 - 3000K 🕮 02 - DARK GREY RAL 7043 Other - Specify VW - Very Wide 65° W35 - 3500K 03 - WHITE RAL 9003 EW - Extra Wide 108° W40 - 4000K 04 - METALLIC SILVER RAL 9006 05 - MATTE SILVER RAL 9006 T1 - Type I Distribution 06 - LIGMAN BRONZE T2 - Type II Distribution T3 - Type III Distribution 07 - CUSTOM RAL T4 - Type IV Distribution **INSPIRED BY NATURE FINISHES** SW01 - OAK FINISH SW02 - WALNUT FINISH SW03- PINE FINISH DF - DOUGLAS FIR FINISH CW - CHERRY WOOD FINISH THERE IS AN ADDITIONAL **ADDITIONAL OPTIONS** COST FOR THESE FINISHES NW - NATIONAL WALNUT FINISH SU01 - CONCRETE FINISH NAT - Natatorium Rated RPA - Round Pole Adapter SU02 - SOFTSCAPE FINISH 4MP - 4" Mounting Plate

CITY OF FLAGSTAFF & TURTLE FRIENDLY COMPLIANT

AMB - Turtle Friendly Amber LED

AMB Spectral Diagram Wavelength (nm)

Narrow-Spectrum Amber LEDs

DIM - 0-10v Dimmina

SCBT - Surface Conduit Box Trim

Peak wavelength between 585 & 595 nanometers and a full width of 50% power no greater than 15 nanometers.

More Custom Finishes Available Upon Request

Consult factory for pricing and lead times





SU03 - STONE FINISH

SU04 - CORTEN FINISH



UMV-30052

Marvik 6 Surface Up/Downlight







IK08 • Impact Resistant (Vandal Resistant)

9.4"

IP65 • Suitable For Wet Locations

6"

Mounting Detail

<u>ø</u>.23"

TECHNOLOGY

distributions for optimized spacing and uniformity.

Ligman's micro Variable Optical System provides the ability

to interchange, mix & rotate optics to provide specific light

Weight 11.6 lbs



Construction

Less than 0.1% copper content – Marine Grade 6060 extruded & LM6 Aluminum High Pressure die casting provides excellent mechanical strength , clean detailed product lines and excellent heat dissipation

Pre paint

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Surge Suppression

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BUG Rating

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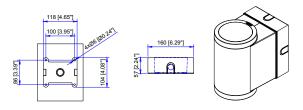
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Ligman can also provide custom made boxes to fit on a round surface like a column, pillar or pole.

Additional Options (Consult Factory For Pricing)



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NOTE: This trim covers a <u>shallow single gang</u>, surface mount junction box [Provided by contractor] Example: Hubbell: - 5322-0 - 1-Gang Weatherproof Box, Five 1/2" in Threaded Outlets - or - 5332-0 1-Gang Weatherproof Box, Five 3/4 in. Threaded Outlets





TYPE I & TYPE IV

The variable optic system allows for the designer to create

hybrid distributions for precise lighting requirements.

UMV-30052


Marvik 6 Surface Up/Downlight





PROJECT DATE QUANTITY NOTE **TYPE** ORDERING EXAMPLE || UMV - 30052 - 2x20w - M - W - W30 - 02 - 120/277v - Options UMV-30052 LAMP **BEAM UP BEAM DOWN LED COLOR FINISH COLOR VOLTAGE** 2x20w LED M - Medium 32° 120/277v M - Medium 32° W27 - 2700K 01 - BLACK RAL 9011 Other - Specify 2x1627 Lumens W - Wide 52° W - Wide 52° W30 - 3000K 02 - DARK GREY RAL 7043 W35 - 3500K VW - Very Wide 65° VW - Very Wide 65° 03 - WHITE RAL 9003 EW - Extra Wide 108° EW - Extra Wide 108° W40 - 4000K 04 - METALLIC SILVER RAL 9006 T1 - Type I Distribution T1 - Type I Distribution 05 - MATTE SILVER RAL 9006 T2 - Type II Distribution T2 - Type II Distribution 06 - LIGMAN BRONZE T3 - Type III Distribution T3 - Type III Distribution 07 - CUSTOM RAL T4 - Type IV Distribution T4 - Type IV Distribution INSPIRED BY NATURE FINISHES SW01 - OAK FINISH SW02 - WALNUT FINISH SW03- PINE FINISH **ADDITIONAL OPTIONS** DF - DOUGLAS FIR FINISH CW - CHERRY WOOD FINISH THERE IS AN ADDITIONAL NAT - Natatorium Rated RPA - Round Pole Adapter COST FOR THESE FINISHES **NW - NATIONAL WALNUT FINISH** 4MP - 4" Mounting Plate SU01 - CONCRETE FINISH DIM - 0-10v Dimming AMB - Turtle Friendly Amber LED SU02 - SOFTSCAPE FINISH SCBT - Surface Conduit Box Trim SU03 - STONE FINISH SU04 - CORTEN FINISH

CITY OF FLAGSTAFF & TURTLE FRIENDLY COMPLIANT

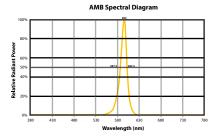


Narrow-Spectrum Amber LEDs

Peak wavelength between 585 & 595 nanometers and a full width of 50% power no greater than 15 nanometers.

More Custom Finishes Available Upon Request

Consult factory for pricing and lead times

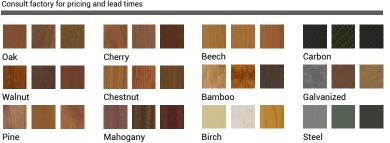





Existing Conditions: Front Facade



Rendering: Proposed Alterations



325 MANVILLE ROAD

ALTERATIONS

Manville and Grove, LLC 325 Manville Road Pleasantville, NY 10570

Gallin Beeler Design Studio, PLLC 23 Washington Avenue Pleasantville NY, 10570

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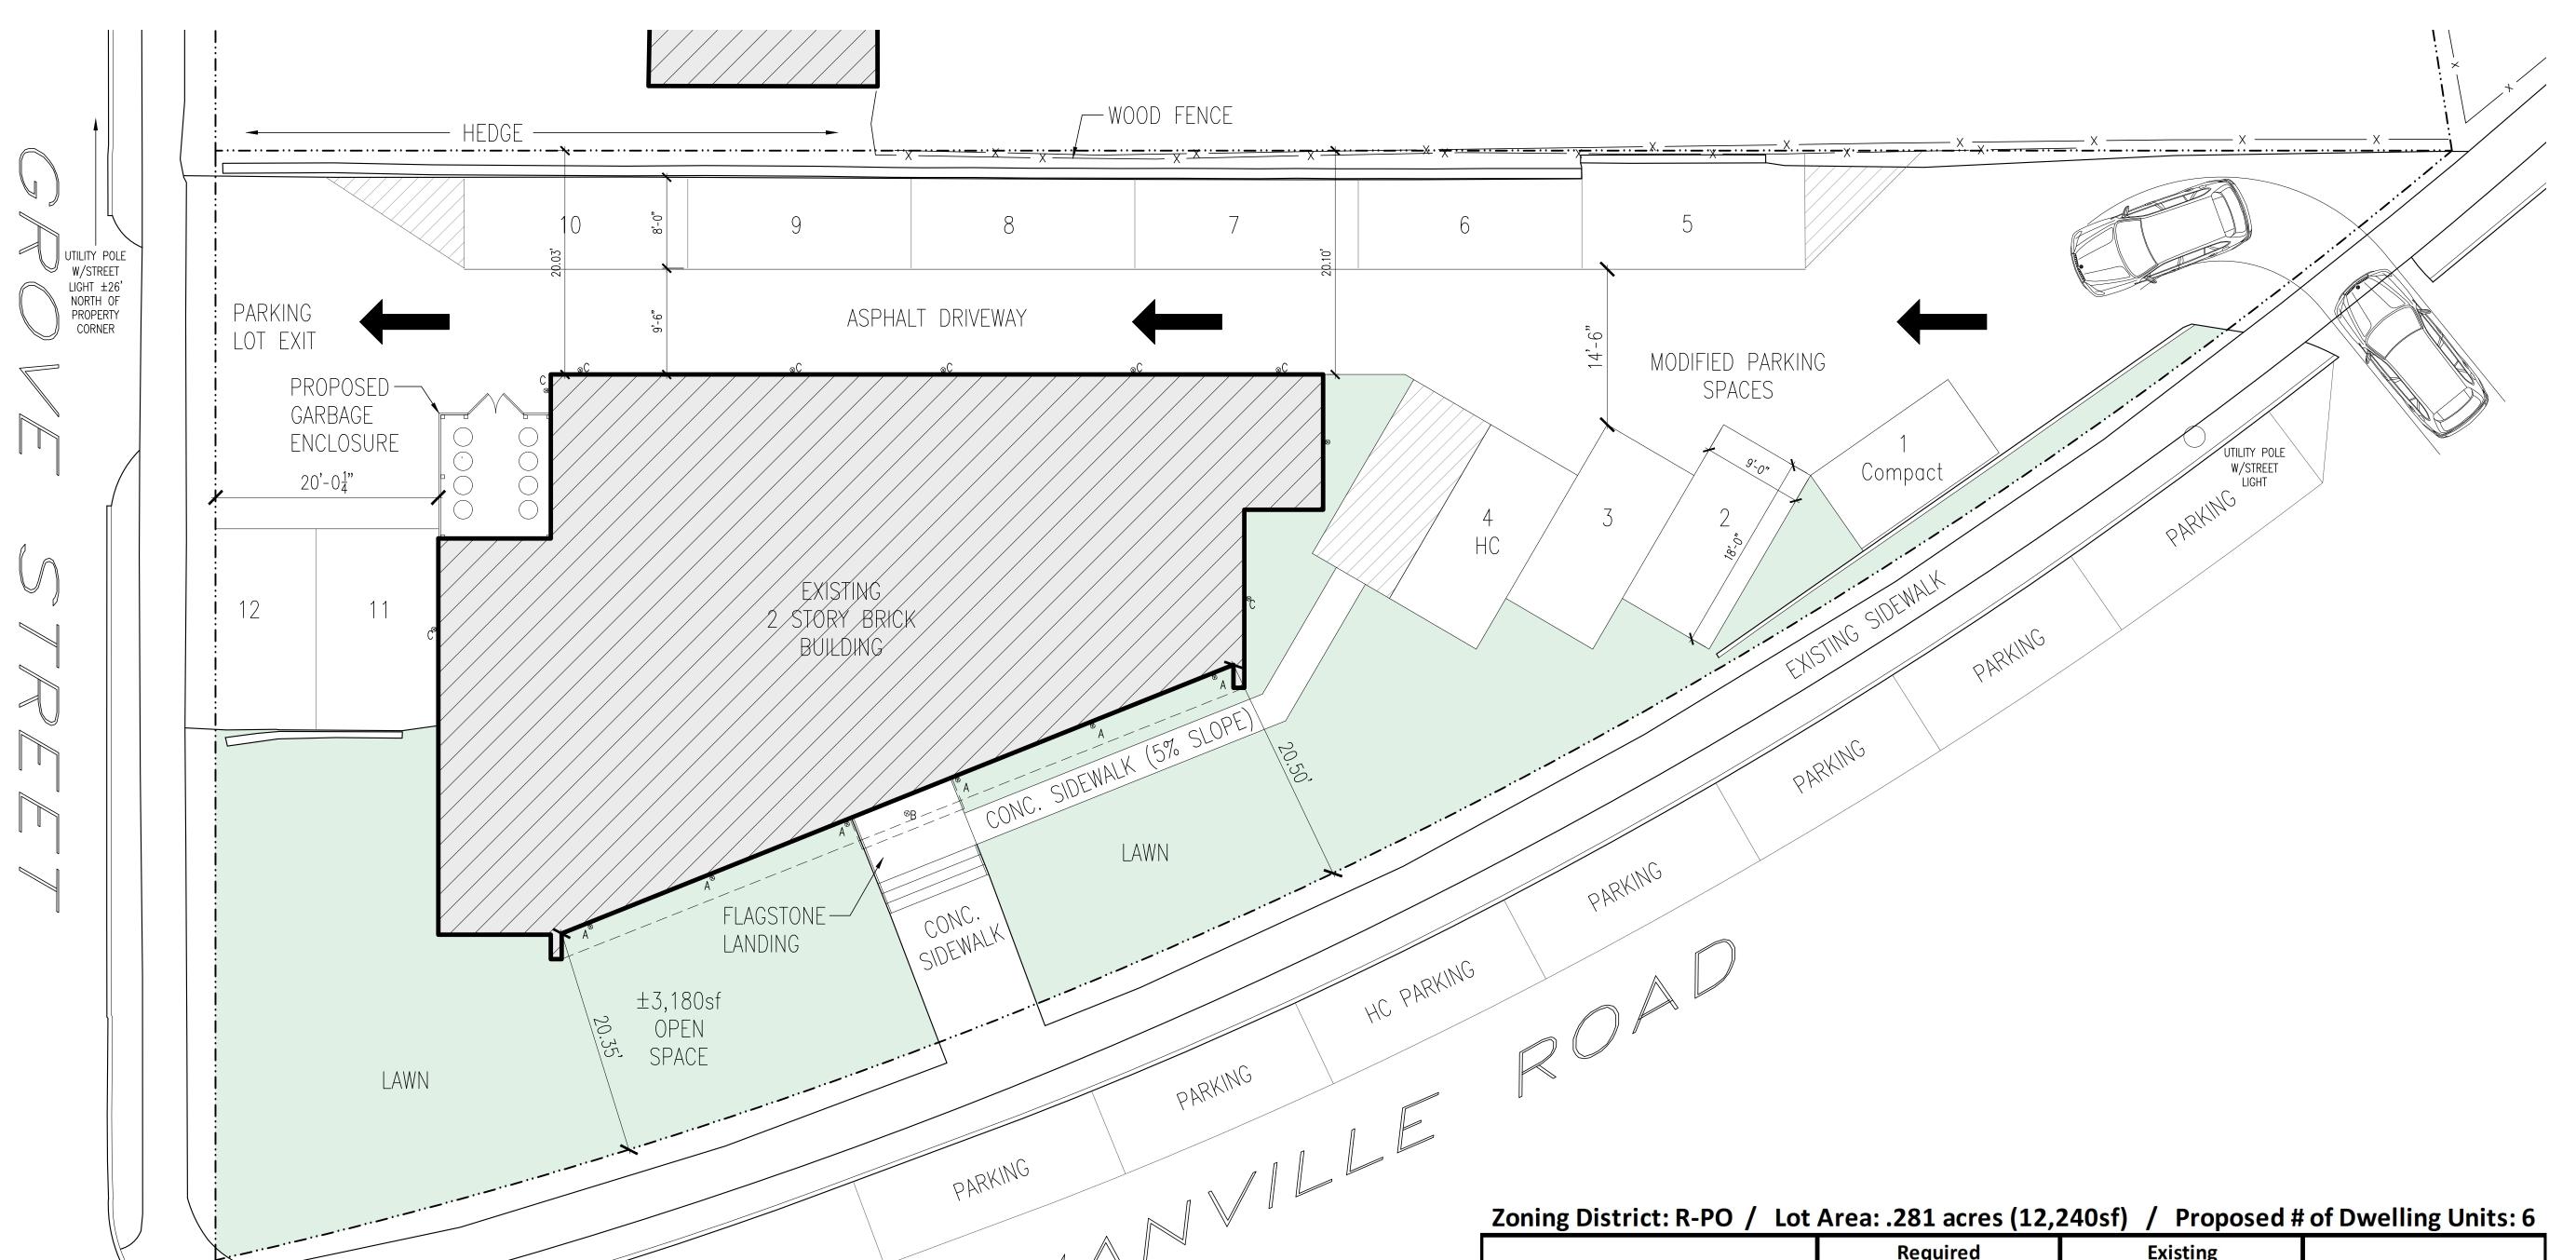
Sheet Title:

Cover Sheet

Print Date: 03-27-25

Project #: 2501 Drawn: RB Checked: RB

A00



12,240.5sf

3,179sf

9,061.5sf (74.0%)

UTILITY POLE W/STREET LIGHT

Existing Developed Area

Pervious Area - i.e. grass

Existing Developed Area

Site Area

Proposed Site Plan

12,240.5sf

3,119.5sf

9,121sf (74.52%)

Proposed Developed Area

Pervious Area - i.e. grass

Proposed Developed Area

Site Area

SCALE 1/8" = 1'-0"

	Required / Allowed	Existing / Proposed	Compliant
Minimum Lot Area	20,000sf	12,240.5sf	Variance Required
Minimum Lot Frontage	75'	225'	Yes
Minimum Lot Width	75'	approx. 200'	Yes
Minimum Lot Depth	100'	varies from 99' to 0'	*PENC
Minimum Front Yard	30'	20.35'	*PENC
Minimum Side Yard	30'	20.01'	*PENC
Minimum Rear Yard	30'	20.03'	*PENC
Minimum Gross Area per Dwelling Unit	800sf	930sf	Yes
Maximum Height	2.5 stories / 30'	2 stories / 22'	Yes
Maximum Building Coverage	30%	22.80%	Yes
Maximum Developed Coverage	60%	74.5% existing 74% proposed	74% *PENC reduced
Maximum FAR	0.4	0.46	*PENC
Maximum Open Space	400sf per dwelling unit	3,200sf	Yes
Parking	2 spaces per dwelling unit	12 spaces	Yes

*PENC = Pre-Existing Non-Conformance

MANVILLE ROAD

ALTERATIONS

Manville and Grove, LLC


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SUSTAINABILITY FACTORS

TRESPA PANELS

Carbon Capture: Using up to 70% wood fibres, they capture and lock in CO2 absorbed by trees during their growth. When used in ventilated facades, these panels improve energy efficiency by cutting emissions from heating and cooling, helping reduce your project s overall carbon footprint.

Ecofriendly Material: 85% of the materials used to make the panel come from renewable, plant based sources rather than fossil-fuel based materials like plastics.

Durability & Waste Reduction: The combination of wood fibers and Trespa's high-pressure laminate process creates long lasting panels, minimizing material waste overtime.

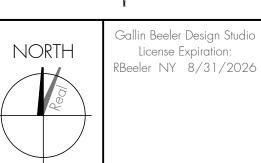Green Company: since 2020, Trespa powers all operations with 100% green electricity

HEAT PUMPS

Energy Efficiency: heat pumps produce 3-4 times more energy than they consume. This reduces the amount of energy needed to heat or cool a space, leading to lower energy consumption

Lower Carbon Emissions: only use electricity and do not burn fossil fuels. Produce fewer greenhouse gas emissions compared to traditional heating systems


Versatility: provides both heating and cooling, replacing the need for a separate system for each

SPRAY FOAM INSULATION


Energy Efficiency: creates an airtight seal that prevents air leaks, which help maintain consistent indoor temperatures and lead to a lower energy consumption.


ADAPTIVE REUSE OF EXISTING BUILDING


NEW ENERGY EFFICIENT WINDOWS

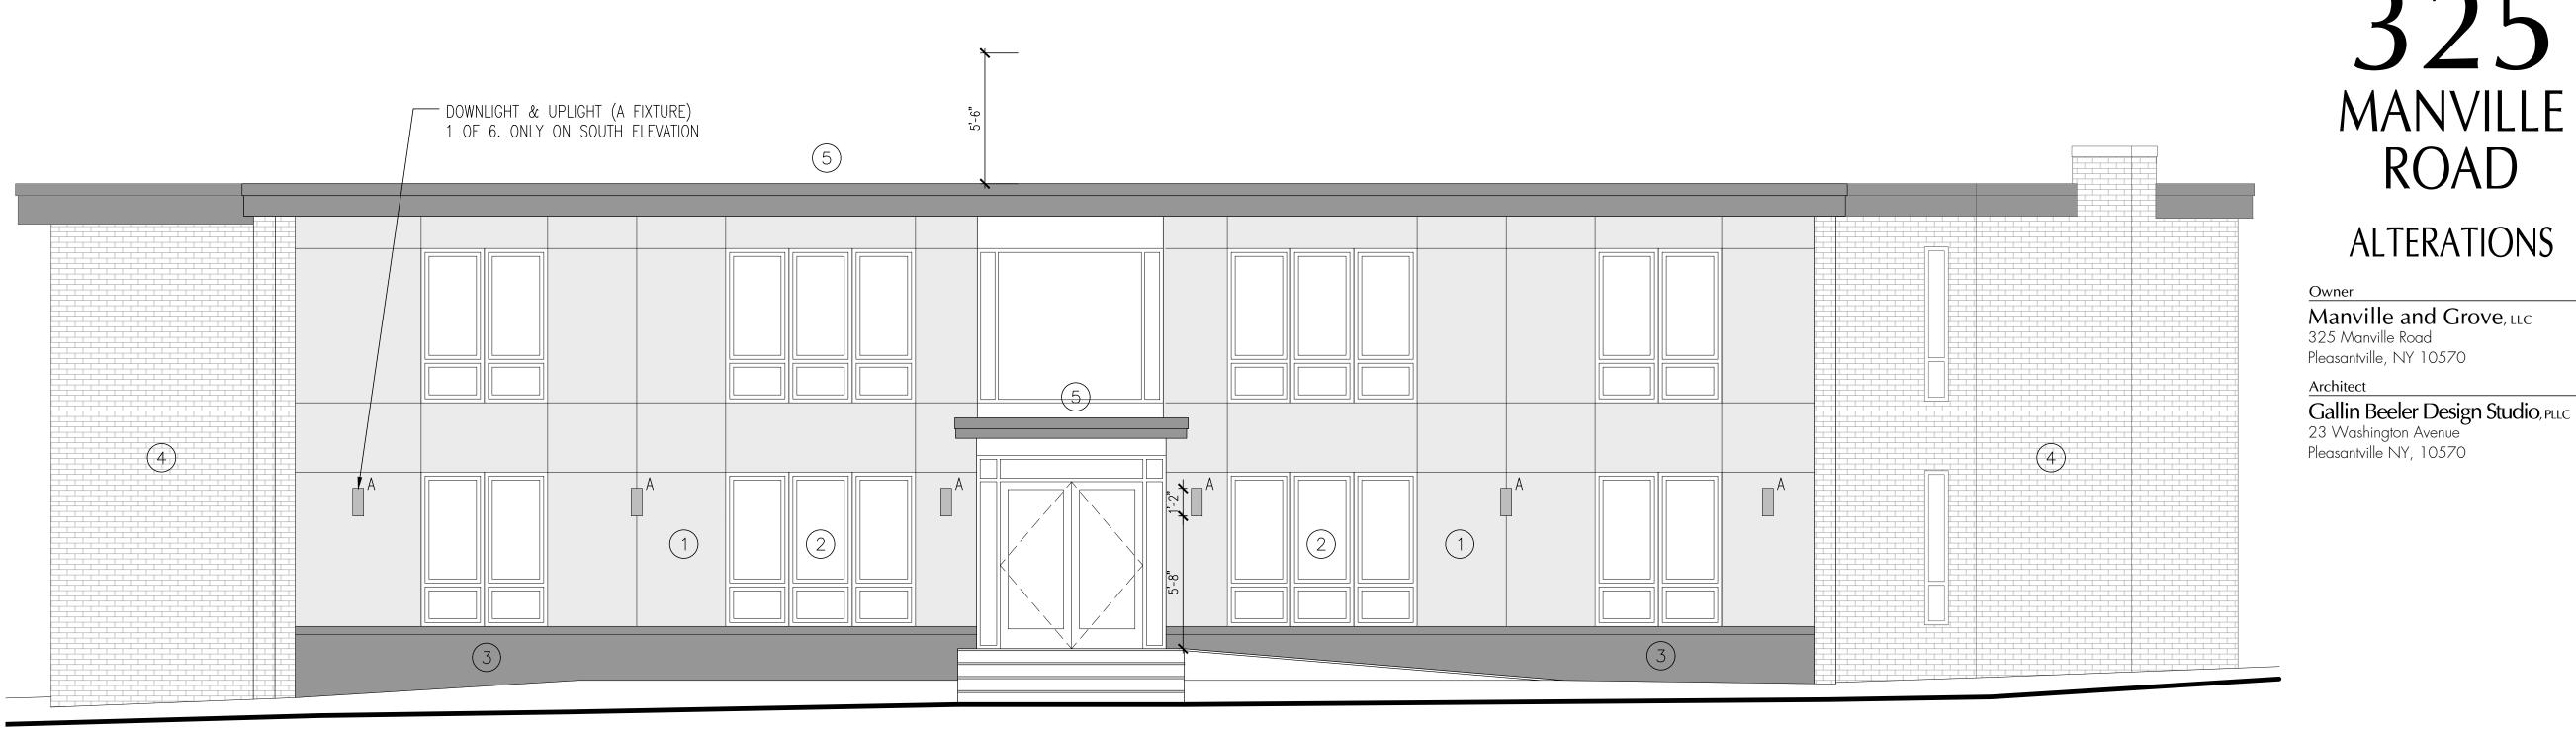

- NEW TRESPA RAINSCREEN PANELS
- NEW ALUMINUM WINDOWS
- BLACK GRANITE
- EXISTING BRICK
- METAL ROOF EDGE CLADDING

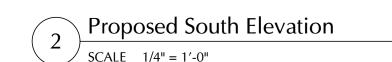

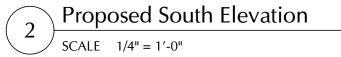

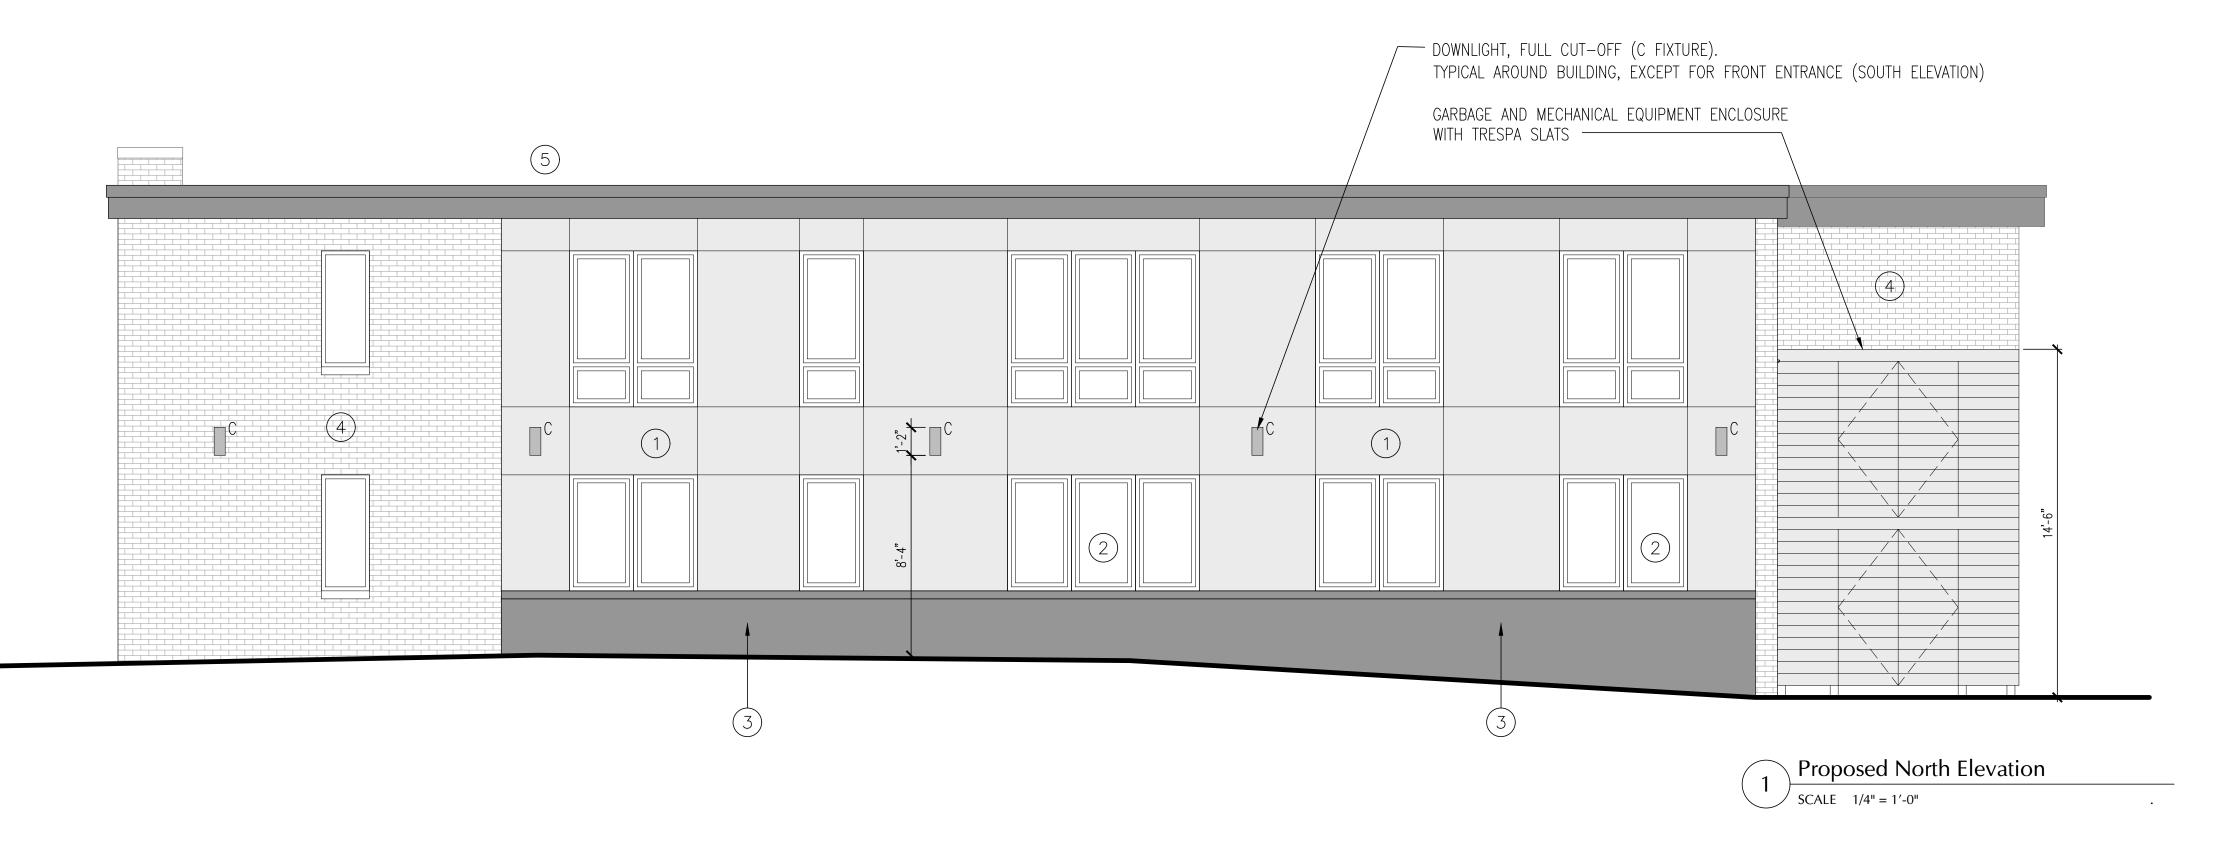

Planning Board Submission

325

MANVILLE

ROAD

ALTERATIONS

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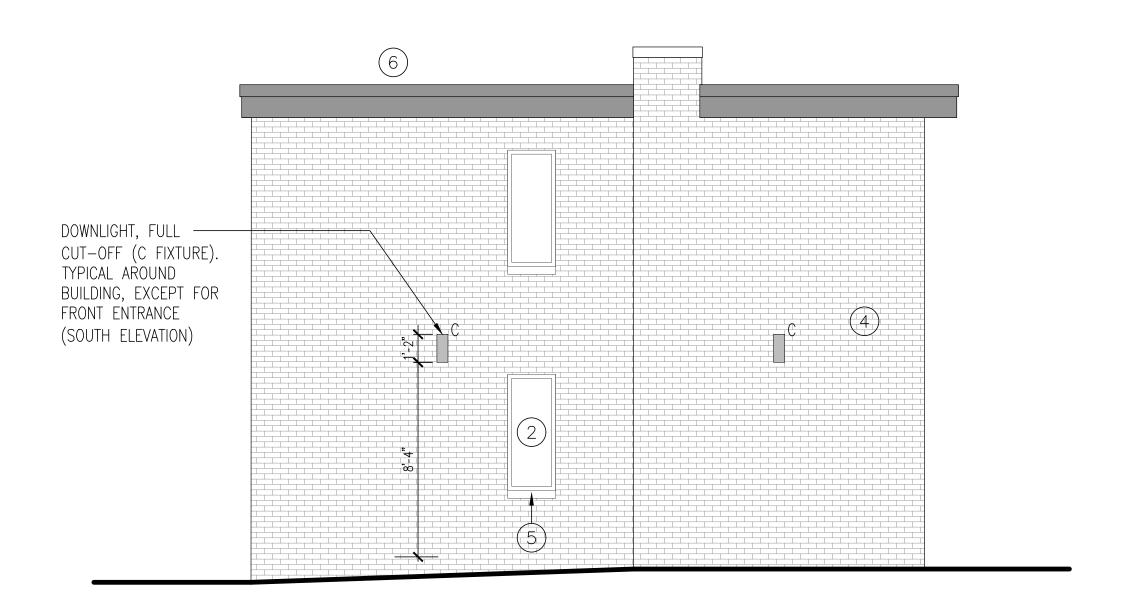
Proposed Elevations & Sustainability Factors

Project #: 2501 Drawn: RB Checked: RB


Print Date: 04-08-25

A20

Sheet No.:



- NEW ALUMINUM WINDOWS
- EXISTING BRICK
- NEW CAST STONE SILLS
- METAL ROOF EDGE CLADDING

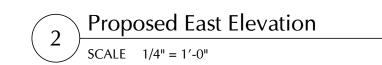

6 DOWNLIGHT, FULL

CUT-OFF (C FIXTURE).

TYPICAL AROUND

BUILDING, EXCEPT FOR FRONT ENTRANCE (SOUTH ELEVATION) GARBAGE AND MECHANICAL EQUIPMENT ENCLOSURE WITH TRESPA SLATS

> \ Proposed West Elevation SCALE 1/4" = 1'-0"

MANVILLE ROAD **ALTERATIONS**

Manville and Grove, LLC 325 Manville Road Pleasantville, NY 10570

Architect

Gallin Beeler Design Studio, PLLC 23 Washington Avenue Pleasantville NY, 10570

Planning Board Submission

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O4.08.25 Planning Brd. Submission
 O3.27.25 Zoning Brd. Submission
 O2.12.25 Planning Brd. Submission
 Rev. Date Description

Sheet Title:

Proposed Elevations

Project #: 2501 Sheet No.: Drawn: RB Checked: RB

A22 Print Date: 04-08-25



Proposed 1st Floor Plan SCALE 1/4" = 1'-0"

(3) 2 BEDROOM UNITS

325 MANVILLE ROAD

ALTERATIONS

Manville and Grove, LLC 325 Manville Road Pleasantville, NY 10570


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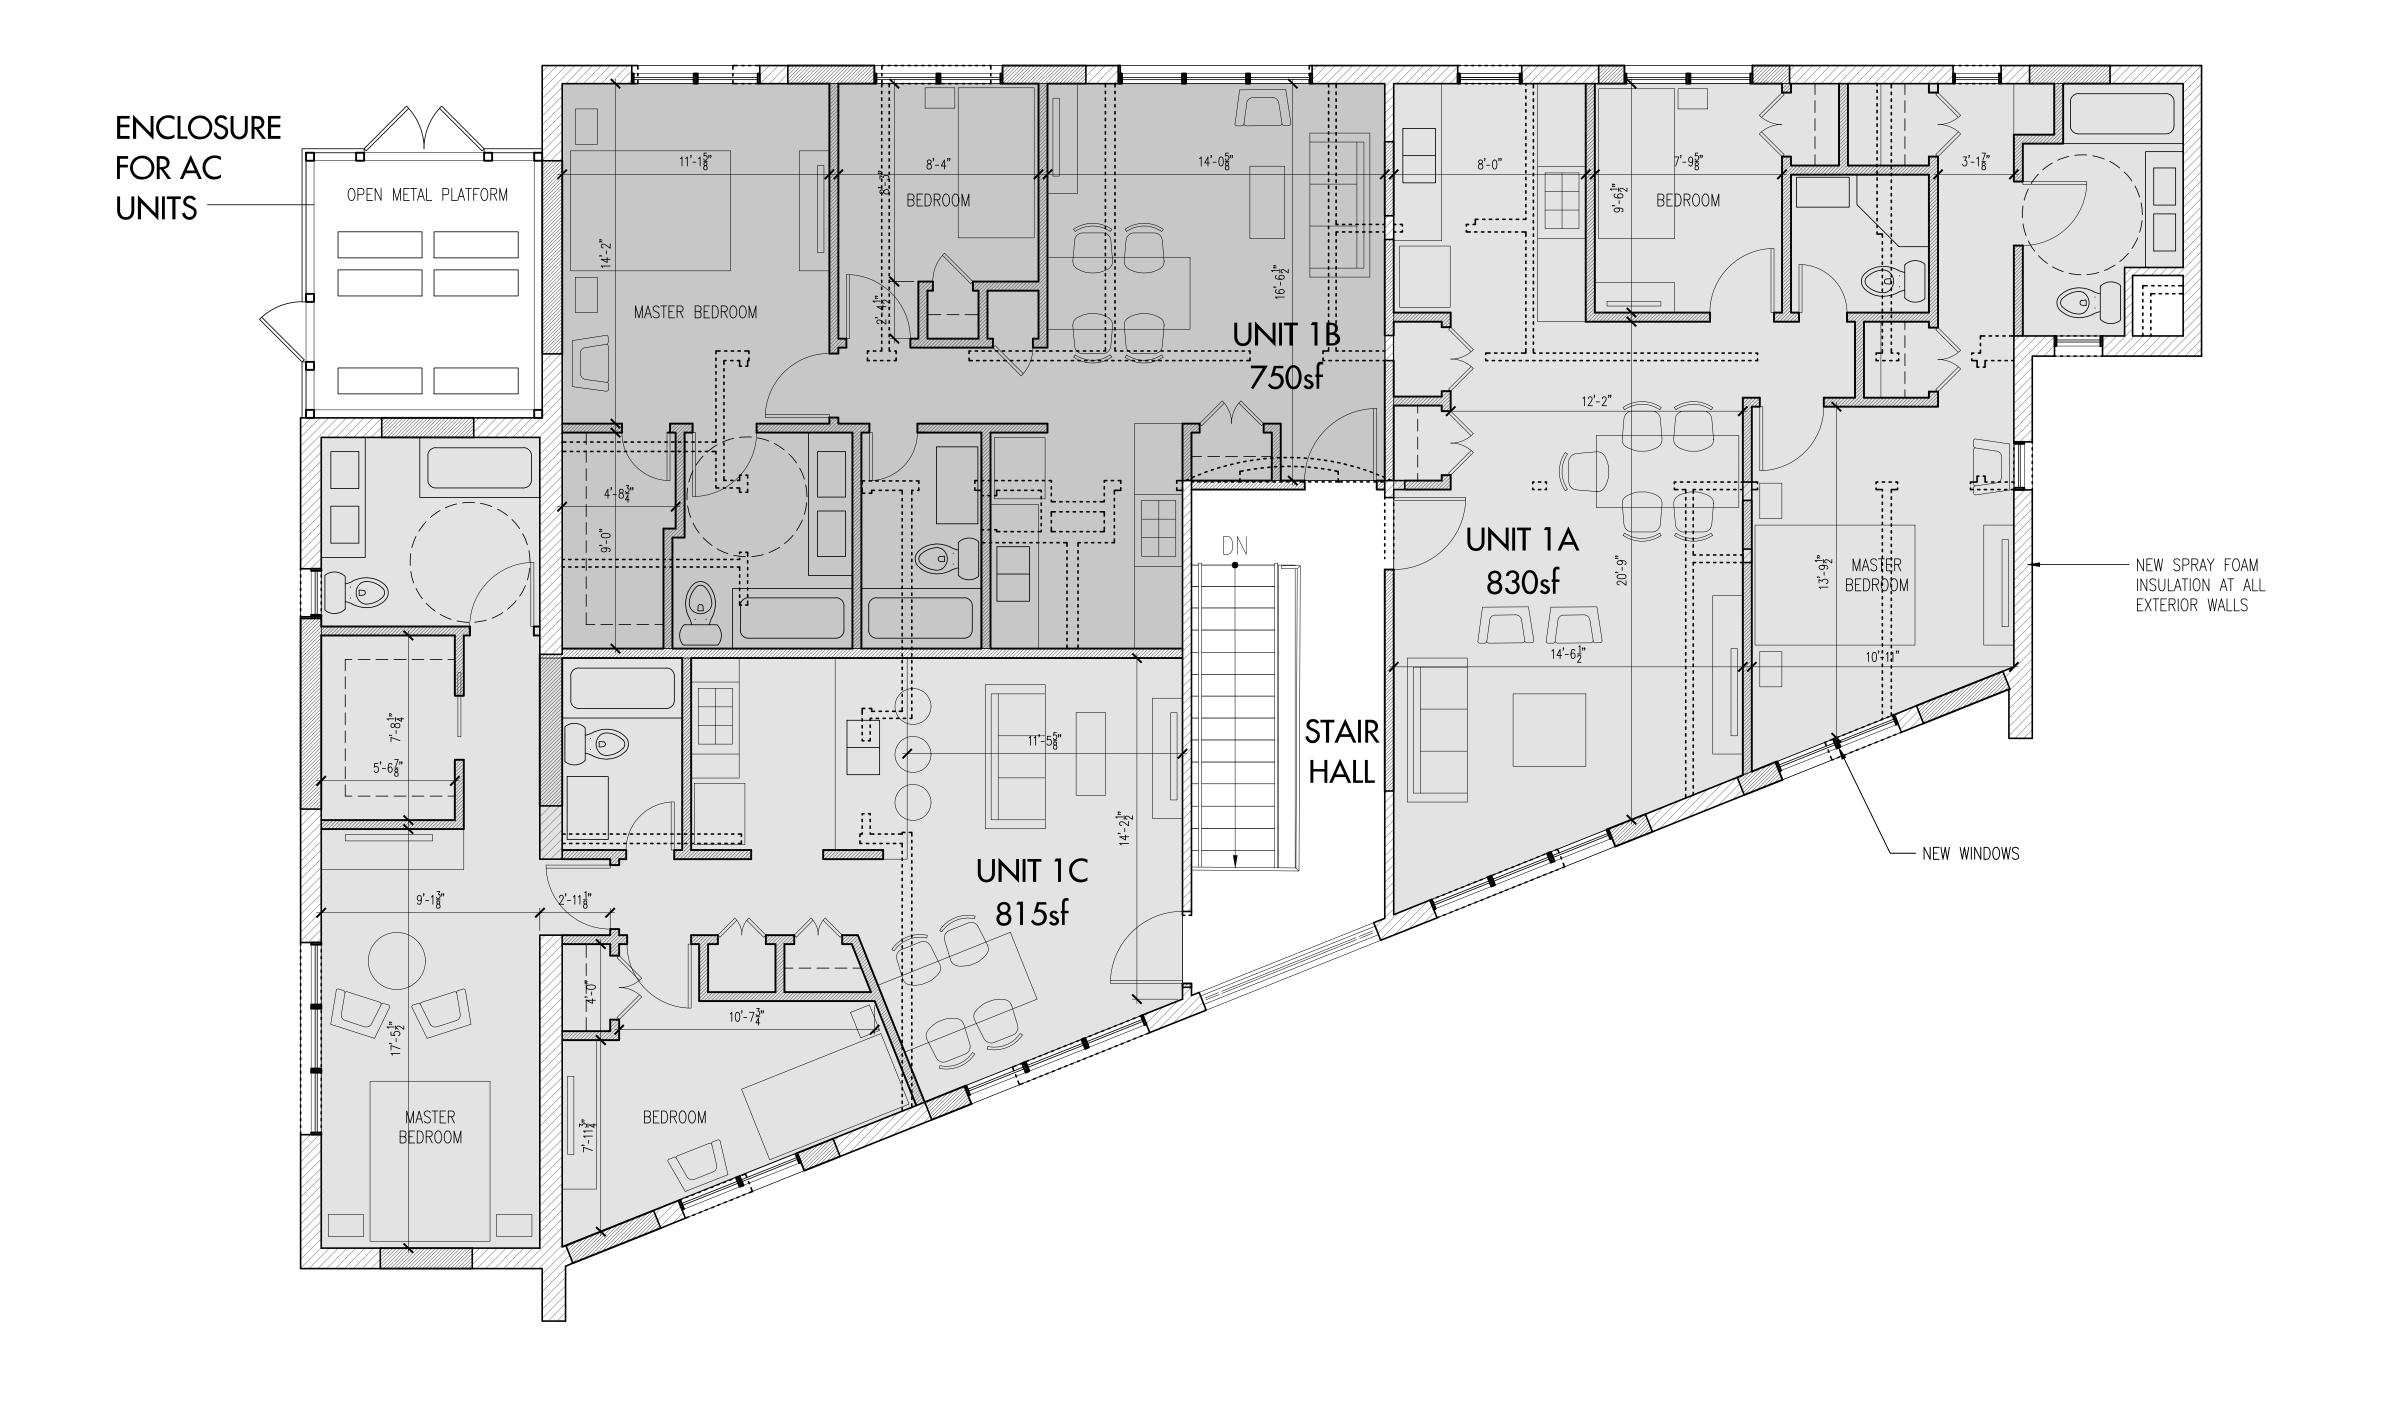
Sheet Title:

Proposed 1st Floor Plan

Project #: 2501 Drawn: RB Checked: RB

Print Date: 04-08-25

Sheet No.: A10

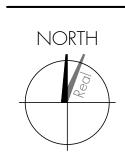

Proposed 2nd Floor Plan SCALE 1/4" = 1'-0"

(3) 2 BEDROOM UNITS

325 MANVILLE ROAD

ALTERATIONS

Manville and Grove, LLC 325 Manville Road Pleasantville, NY 10570


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O4.08.25 Planning Brd. Submission
 O3.27.25 Zoning Brd. Submission
 O2.12.25 Planning Brd. Submission
 Rev. Date Description

Sheet Title:

Proposed 2nd Floor Plan

Project #: 2501 Drawn: RB Checked: RB

Print Date: 04-08-25

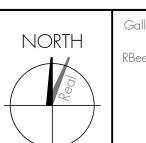Sheet No.: A12 Existing Conditions: Front Facade



Rendering: Proposed Alterations




Sheet List

A23

	Architectural	
A00	Cover Sheet	
A01	Survey	
A02	Surrounding Buildings	
A03	Previously Approved Site Plan	
A04	Proposed Site Plan	
A05	Landscape Plan	
A10	Proposed 1st Floor Plan	
A11	Existing 1st Floor Plan	
A12	Proposed 2nd Floor Plan	
A13	Existing 2nd Floor Plan	
A20	Proposed Elevations & Sustainability Factors	
A21	Existing Elevations	
A22	Proposed Elevations	

Existing Elevations

Existing Aerial Map

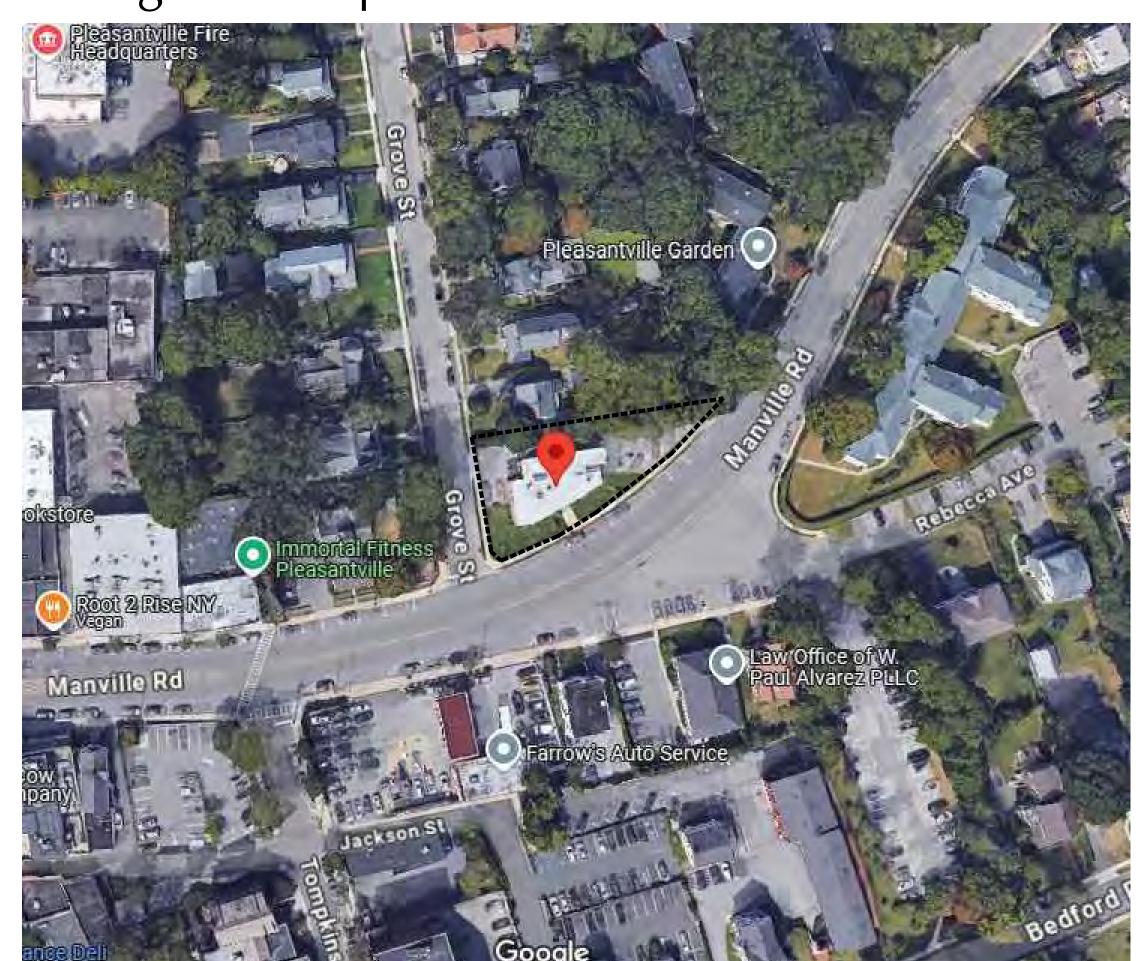

325 MANVILLE ROAD

ALTERATIONS


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Planning Board Submission

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- O2.12.25 Planning Brd. Submission
Rev. Date Description

Sheet Title:

Cover Sheet

Project #: 2501 Drawn: RB Checked: RB Print Date: 02-12-25

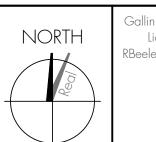Sheet No.: A00



Westchester County Planning Board Referral Review

Pursuant to Section 239 L, M and N of the General Municipal Law and Section 277.61 of the County Administrative Code

Kenneth W. Jenkins Westchester County Executive

March 25, 2025

Robert Hughes, Building Inspector Village of Pleasantville, NY 80 Wheeler Avenue Pleasantville, NY 10570

County Planning Board Referral File PLV 25-002 – 325 Manville Road Site Plan Approval

Dear Mr. Hughes:

The Westchester County Planning Board has received a site plan (dated February 12, 2025) and related materials for a proposed site plan application to redevelop an existing office building located at 325 Manville Road (SBL 106.6-1-17). The site is located on the corner of Manville Road and Grove Street within the RPO – Residence Professional Office district, and is located within the downtown and near the Pleasantville Metro-North train station. The existing two-story building contains six commercial office tenant spaces, served by a 12-space parking lot connecting through the site to both roads.

The applicant proposes to convert the structure into an apartment building containing six two-bedroom units, with the footprint of the building remaining the same. The parking lot, while remaining 12 spaces, would be slightly expanded to make one of the spaces ADA compatible, and a new ramp would connect this space to the front door. New landscaping would be installed within the front yard, and the building would receive a new façade.

We have reviewed this matter under the provisions of Section 239 L, M and N of the General Municipal Law and Section 277.61 of the County Administrative Code and we offer the following comments:

1. Consistency with County Planning Board policies.

The County Planning Board's long-range planning policies set forth in *Westchester 2025—Context for County and Municipal Planning and Policies to Guide County Planning*, adopted by the Board on May 6, 2008, amended January 5, 2010, and its recommended strategies set forth in *Patterns for Westchester: The Land and the People*, adopted December 5, 1995, call for directing new development to existing centers where infrastructure can support growth, where public transportation can be provided efficiently, and where redevelopment can enhance economic vitality. We appreciate that the proposed plan follows these strategies, and that the applicant is proposing the reutilization of an existing building.

2. Affirmatively Furthering Fair Housing (AFFH).

While the proposed six new residencies fall under the 10-unit count that would require the developer to provide an affordable AFFH housing unit, we recommend the Village and applicant consider including affordable housing within the proposed development. The acute shortage of affordable housing in

Website: westchestergov.com

Telephone: (914) 995-4400

Westchester County has been documented in the County's *Housing Needs Assessment*, and it is critical for any proposed development to play a role in meeting this need.

3. Displacement assistance.

We note that the commercial usage within the site would be discontinued, with the application stating that 50% of the building is currently in use. Displacement assistance policies such as moving cost subsidies and real estate assistance provided by the developer should be considered by the Village, should need be established by any current tenants of this building.

4. Parking layout.

While we note that the general layout of the parking lot is proposed to remain the same, with the exception of the added ADA space, we are concerned that this layout may be too constricted for residential use. We specifically question the two spaces near the Manville Road entrance, as they do not seem to be of sufficient size. We recommend that the applicant and the Village work to either reconfigure these spaces to provide standard dimensions, or to permit a site plan with less parking than the required two spaces per unit. We note that as the site is near the Pleasantville train station and other forms of transit, 12 spaces for a six-unit building may prove to be excessive, despite each unit being two bedrooms.

5. NYS DOT review.

Manville Road (NYS Route 117) is a State highway. The Village should forward a copy of the application to NYS DOT to identify any required permits for the proposed project and to evaluate potential traffic impacts to Manville Road.

6. Sewage flows.

The proposed development may increase sewage flows from this site into the existing infrastructure. Any increased flow will add to the volume of sewage flow requiring treatment at a Water Resource Recovery Facility operated by Westchester County. Since 2010, it has been the policy of the County Planning Board that municipal governments require the applicant to identify mitigation measures that will offset projected increases in flow. The best means to do so is through reductions in inflow/infiltration (I&I) at a ratio of three for one for market rate units and a ratio of one for one for affordable AFFH units.

The County Planning Board further recommends that the Village implement a program that requires inspection of sewer laterals from private homes for leaks and illegal connections to the sewer system, such as from sump pumps. These private connections to the system have been found to be a significant source of avoidable flows. At a minimum, we encourage the Village to enact a requirement that a sewer lateral inspection be conducted at the time property ownership is transferred and any necessary corrective action be enforceable by the municipal building inspector.

7. Bicycle parking.

We recommend that a bicycle parking area be provided within the site for residents, which includes electrical outlets to charge e-bicycles. We note that as the popularity of e-bicycles increases, there is a fire risk associated with non-UL certified batteries, particularly when tenants charge them with extension cords. Providing a centralized, sprinklered storage facility with appropriate outlets for charging is the best way to prevent fires and accommodate this form of transportation to and from the building.

8. Green building technology.

We encourage the applicant to include as much green, or sustainable building technology as possible within the proposed development. We suggest that the applicant consider utilization of the rooftop as the building is redeveloped, such as the installation of solar arrays or a green roof.

9. Provisions for recycling.

The Village should require the applicant to verify that there is sufficient space to accommodate the storage needs for recyclables under the County's recycling program. County regulations for recycling may be found at: https://environment.westchestergov.com/recycling.

10. Universal Design.

We appreciate that the applicant is including ADA-accessible parking and front doorway access within the redevelopment, and encourage the Village to consider further principles of universal design in this development. Universal Design standards allow all residents and visitors to fully engage in our public and residential spaces. Universal Design is also an important means of enabling household residents to age in place as well as to provide further increased access for persons with mobility issues.

Please inform us of the Village's decision so that we can make it a part of the record.

Thank you for calling this matter to our attention.

Respectfully.

WESTCHESTER COUNTY PLANNING BOARD

Bernard Thombs

Chair, Westchester County Planning Board

BT/mv

cc: Blanca Lopez, Commissioner, Westchester County Department of Planning

Vincent Kopicki, Commissioner, Westchester County Department Environmental Facilities

Anne Darelius, NYS Department of Transportation, Region 8 Christopher Lee, NYS Department of Transportation, Region 8

Paul Januszewski, Vice President - Project Executive, MTA Construction and Development (TOD)



411 Theodore Fremd Avenue Suite 206 South Rye, NY 10580 T: 914.967.6540 www.hardestyhanover.com

MEMORANDUM

To: Russell Klein, Chairman,

and the Village of Pleasantville Planning Commission

Date: April 9, 2025

Subject: Manville and Grove, LLC – 325 Manville Road – Site Plan Application

The Applicant has submitted a plan set for review as part of the Site Plan application for the property located at 325 Manville Road. The application involves the conversion of the existing office building into 6 residential apartments.

We provided the following comments based on our review of the submission:

<u>SEQRA.</u> The Proposed Action is a Type II action with requires no further review under SEQRA.

Lighting Plan.

- a. The Proposed Site Lighting Plan and manufacturer specification sheets should note the color temperature for proposed fixtures "A" and "C." We also recommend that the fixtures that have uplighting be replaced with the downlight fixtures. It has been the past practice of the Planning Commission to avoid uplighting because it is not Dark Sky compliant.
- b. The legend on the Proposed Site Lighting Plan notes 3 different fixtures. However, the exterior lighting statistics sheet notes 5 different fixtures. The Applicant should verify that all proposed lighting is shown on the Proposed Site Lighting Plan.

<u>Site Plan</u>. We have reviewed the maneuverability of the existing parking plan, specifically existing parking spaces 11 and 12. As shown, the spaces will allow cars to back out and exit the site without conflicting with a car in space 10. If the Applicant or the Commission would like to have more maneuverability in that area, there may be an opportunity to slightly reduce the trash enclosure since it shows eight trash receptacles for six apartments.

If you have any questions, please do not hesitate to contact our office.

Sarah L. Brown, AICP Associate, Principal Planner

cc: Robert Hughes, Building Inspector



Minutes of Meeting Meeting of March 12, 2025

ATTACHMENTS:

Description	Type	Upload Date
PC Meeting 3.12.25	Backup Material	4/4/2025
ARB Meeting 3.12.25	Backup Material	4/4/2025

Pleasantville Planning Commission March 12, 2025

The Pleasantville Planning Commission meeting was called to order by Russell Klein, Chairman, at approximately 8:20 pm on Wednesday, March 12, 2025. Attending the meeting were Erik Brotherton, Perry Freitas, David Keller and Henry Leyva, Commissioners, Sarah Brown, Planning Consultant (via Zoom) and Robert Hughes, Building Inspector.

Applications Specific to the Planning Commission

3. <u>Prospero – 134 Marble Avenue</u> – Proposal to amend prior site plan resolution and implement warehouse with retail use via Special Permit within existing first floor from prior non-conforming manufacturing, assembling and warehouse use – *Continued review* – *applicant back from ZBA*. Present: James Flandreau

Mr. Flandreau reported that the Zoning Board granted them a variance to use 20% of the warehouse space for retail.

Mr. Flandreau said the site plan and floor plan are pretty much the same as what was approved by the Planning Commission last year, other than some small modifications to the area where the bathrooms are.

Regarding the Commission's question about what type of vehicles would make deliveries, Mr. Flandreau said the business has three box trucks, which would make deliveries once to twice a week. There is a loading dock that the trucks will be able to pull into.

Mr. Flandreau said the retail space will be the showroom for the warehouse. It will be a sample showroom, and all the carpets and flooring materials will be stored in the warehouse space. Retail transactions will typically not take place. People can place orders and materials will be delivered.

Ms. Brown's only question was if there was room for the delivery trucks, which was addressed, and if the trucks could be accommodated on-site. Mr. Flandreau said one truck will be parked in the loading dock and the other two will be in the parking lot. They will move the garbage enclosure if necessary to accommodate the two trucks. Mr. Hughes said there would be sufficient parking for customers even if all three trucks are on-site.

Mr. Flandreau believed Floorcraft did installations, but if a contractor came in a van to load material, he could use the loading dock.

Ms. Brown added that because it is a Special Use Permit, the Board is required to hold a Public Hearing. Mr. Klein noted that Special Use Permits typically have a 5-year term limit, at which time the applicant would have to come back before the board to renew the permit.

Pleasantville Planning Commission March 12, 2025

A Public Hearing will be scheduled for April 9. Mr. Klein said they could have Ms. Brown prepare the Resolution and if no issues are raised during the Public Hearing, the Commission can vote that evening.

Applications Involving Planning and Architectural Review Board

4. <u>325 Manville Road – Manville and Grove LLC</u> – Proposed conversion of existing professional office building into a new multiple dwelling consisting of a maximum of six residential apartment units. *Continued review – referral to ZBA*. Present: Dan Merritts, Contractor and Ray Beeler, Architect.

Mr. Klein said this was the Board's second review of this application for referral to the Zoning Board, with emphasis this evening on last meeting's discussion about parking.

Mr. Merritts said their original plan increased asphalt coverage by about 465 square feet. He said that based on the Board's comments, Mr. Beeler came up with a new plan that excluded the 465 square feet of asphalt and moved some things around, resulting in a reduction in lot coverage of 60 square feet and eliminating the need for the coverage variance.

Mr. Beeler said they looked at the whole area carefully. They moved the spaces up a bit by tipping them at a 60-degree angle. They discovered that a 14'6" one-way drive aisle is recommended for parking spaces at a 60-degree angle. All the spaces are legal – three full-size and one compact.

Mr. Beeler added the grass surface increased a bit and the impervious surface decreased a little so that they don't need any variance for coverage. He said the only variance that they would still need would be for the lot size.

Mr. Beeler said they looked at the grades and said they will not need a ramp. The sidewalk slope will be 5%, so they will not need handrails either.

Mr. Klein pointed out that this instance was a great example of how applicants can benefit from coming to the Planning Commission before going to the Zoning Board – sometimes working with an applicant helps avoid the need for variances.

Mr. Beeler said the garbage enclosure and the flow of traffic were the same as what was presented last time. Mr. Klein said in one of their future meetings they could discuss ways to prevent the garbage trucks pick-up from going over the grass and destroying the curb. Mr. Merritts said they could look at plantings or something. Mr. Klein thought that could be a good solution.

Pleasantville Planning Commission March 12, 2025

Mr. Klein thought the parking improvements looked great. The Board liked the plans very much.

Ms. Brown said she had the traffic engineers take a quick look and overall, they didn't have issues.

She said it would help if the applicant could put the dimension between the outline of the parallel

space and the building so they could have an exact number to look at.

5. <u>Landmark at 444</u>

The applicant asked to be on next meeting's agenda.

6. <u>Minutes</u>

Mr. Klein had one correction: during the Dan Merritt's application when the public was welcomed

to speak, a homeowner complained about the lights behind him at the "club," and Mr. Klein

believed what he meant to say was the condo.

A motion to approve the Minutes of the February 26, 2025, Architectural Review Board/ Planning

Commission meeting was made by Mr. Freitas, seconded by Mr. Keller and unanimously carried.

Motion to adjourn the meeting was made by Mr. Keller, seconded by Mr. Leva and unanimously

carried.

The meeting was adjourned at approximately 9 pm.

Respectfully submitted,

Mary Sernatinger

Secretary

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Pleasantville Architectural Review Board March 12, 2025

The Pleasantville Planning Commission was called to order by Russell Klein, Chairman, at approximately 8:00 pm on Wednesday, March 12, 2025. Attending the meeting were Russell Klein, Chairman, Erik Brotherton, Perry Freitas, David Keller and Henry Leyva, Commissioners, Sarah

Brown, Planning Consultant (via Zoom) and Robert Hughes, Building Inspector.

Applications Specific to the Architectural Review Board

1. <u>271 Bedford Road - Kevin and Carrie Roberts</u> - Proposed color changes to the exterior

of the existing dwelling – *New application*. Present: Kevin and Carrie Roberts.

Mr. Roberts said the address of the dwelling is 271 Bedford Road, not 270 as listed on agenda.

The applicants came before the Board a couple years ago to change the color of the siding from

brown to white. Since then, they removed all the old siding and put up new hardy clapboard and

hardy shake on top and also added some trim.

The applicants created mock-ups using various colors to help them decide which color palette to

use. Mr. Roberts said their first choice for the siding is Benjamin Moor Lush (green). Rockport

gray (darker than the Lush) will be used for the main trim and Black Forest Green (black) for

detail. They did not bring any paint chips for the Board to view.

Mr. Roberts showed the color pallet that has 4 colors and referring to the rendering explained

where on the house each would be.

Mr. Roberts said they hadn't decided yet what color to use on the two-story bay windows on the

side – the house color or one of the other colors in the pallet.

A motion to approve the application was made by Mr. Freitas and seconded by Mr. Leyva.

VOTING took place as follows:

Ayes - 5 (Messrs. Brotherton, Freitas, Keller, Klein and Leyva)

Noes - 0

Abstain - 0

Absent - 0

1

Pleasantville Architectural Review Board March 12, 2025

2. <u>134 Marble Avenue – Floorcraft –</u> Proposed new business signage for new warehouse / retail tenant – *New application*. Present: Marianne Guttridge representing Floorcraft

Carpet.

Ms. Guttridge said Floorcraft is planning to move their business from Thornwood to 134 Marble

Avenue. They are proposing a basic sign – black background with a white script font. They would

like to have identical signs on the front and the side of the building.

Ms. Guttridge said the signs will measure 17 x 71 inches, flat plastic (thicker than plexiglass). The

signs will not be lit. Mr. Klein pointed out that the plan says the sign measures 84 x 17. Ms.

Guttridge said the sign would be the same width as the door, so whatever that measurement is will

determine the sign width. Both signs will be the same.

Mr. Klein noted there were lights already on the building on either side of the signs, both on the

Marble Avenue side which was above the windows as well as at the main entrance above the doors.

A motion to approve the application was made by Mr. Leyva and seconded by Mr. Keller.

VOTING took place as follows:

Ayes - 5 (Messrs. Brotherton, Freitas, Keller, Klein and Leyva)

Noes - 0 Abstain - 0

Absent - 0

3. Minutes

A motion to approve the Minutes of the February 26, 2025, Architectural Review Board/ Planning

Commission meeting with corrections by Mr. Klein was made by Mr. Freitas, seconded by Mr.

Keller and unanimously carried.

The ARB portion of the meeting ended at approximately 8:20 pm.

Respectfully submitted,

Mary Sernatinger

Secretary

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